# COUNTY ADMINISTRATION OFFICE RENOVATION (PHASE 1) 23-T00040/AP Q22

County of Hernando 15470 Flight Path Drive Brooksville, FL 34604



# County of Hernando County Administration Office Renovation (Phase 1)

1.	Quote Instructions
II.	
III.	·
IV.	Vendor Questionaire

## Attachments:

- A Sample Work Authorization Agreement
- B CA Office Reno Phase 1 Plans (CD)

## 1. Quote Instructions

#### A. TIME OF COMPLETION:

A. Vendor/Contractor agrees that the work will be substantially complete within days to substantial completion (45) calendar days after the commencement date indicated in the Notice to Proceed and ready for final payment within days to final completion (60) calendar days after the date indicated on the Notice to Proceed. Completion time includes material ordering lead times. Materials shall not be ordered by the Vendor/Contractor until the Notice to Proceed has been issued.

#### **B. LIQUIDATED DAMAGES:**

A. Vendor/Contractor hereby agrees that time is of the essence and that a precise determination of actual damages which could be incurred by the County for delay in the completion of the work provided herein would be difficult to ascertain. Accordingly the parties agree that the liquidated damages for those items of damage not otherwise provided for by the Quote Documents, for each and every day that the time consumed in completing the work provided for herein exceeds the time allowed in achieving Substantial Completion and/or Final Completion therefore shall be in accordance with the amount(s) of enter amount of one hundred fifty dollars (\$150.00). The parties specifically agree that the liquidated damages provided herein do not constitute a penalty. The amount of liquidated damages occasioned by the Vendor/Contractor's delay will be deducted and retained out of the monies payable to the Vendor/Contractor. If not so deducted the Vendor/Contractor and sureties for the Vendor/Contractor shall be liable thereof.

#### D. PERFORMANCE AND PAYMENT BOND: - Not Required if Quote is under \$200,000

A. A Performance and Payment Bond issued in a sum equal to one hundred (100%) percent of the total awarded Contract amount by a surety company considered satisfactory by the County and otherwise authorized to transact business in the State of Florida will be required from the successful Bidder for purposes of insuring the faithful performance of the obligations imposed by the resulting Contract and for purposes of protecting the County from lawsuits for non-payment of debts as might be incurred during the successful Bidder's performance under such Contract. When applicable, the performance and payment bond form will be included in the Contract Documents and said form must be properly executed by the surety company and successful Bidder within fifteen (15) calendar days after notification by the County of the County's intent to award the Contract.

- B. If, within fifteen (15) calendar days after notification by the County of the County's intent to award a Contract, the successful Bidder refuses or otherwise neglects to execute the required written Contract or fails to furnish the required Performance and Payment Bond, the amount of the Bidder's Bid security (check or Bid Bond) shall be forfeited and the same shall be retained by the County. No plea of mistake in the Bid or misunderstanding of the conditions of forfeiture shall be available to the Bidder for the recovery of his Bid security or as a defense to any action based upon the neglect or refusal to execute a written Contract.
- C. The surety company must provide an "Increase Rider" to the Performance and Payment Bond or execute the "Consent of Surety and Increase of Penalty" form provided by the County if the Contract is increased by change order.

## 2. Scope of Work

## 2.1. County Administration Office Renovation (Phase 1)

Create office area within large meeting room and three individual offices in existing storage room.

Work to be performed per plans and will include

- constructing new walls
- electrical to include
  - o re-locate
  - modify
  - o or add power & lighting,
- Mechanical
  - o remove existing plenum & duct work,
  - o install new plenum, ducts, & grills,
- Data
  - add chases in walls for data cabling,
- Ceiling
  - o install wall molding and
  - o relocate or install 2 & 4 foot ceiling grid tees.

Electrical, Building, and Mechanical Permits will be required.

## 3. Pricing Proposal

Line Item	Description	Quantity	Unit of Measure	Unit Cost	Total
1	Permitting	1	Lump Sum		
2	Mobilization	1	Lump Sum		
3	Materials and labor to construct new walls per plan	109	Per Lineal Foot		
4	Material and labor to re-locate, modify, and add power & lighting. Include Data chases in walls	1	Lump Sum		
5	Material and labor to remove existing plenum, ducts, and grills. Install new plenum, ducts and grills per plans	1	Lump Sum		
6	Material and labor to install ceiling wall moulding and relocate or add 2 & 4 four-foot ceiling grid tee's per plans	1	Lump Sum		
TOTAL	,	1	1		1

## 4. Vendor Questionaire

### 4.1. Bid Confirmation\*

The undersigned, hereinafter called "Bidder", having visited the site of the proposed project and familiarized himself with the local conditions, nature and extent of the work, and having examined carefully the agreement form, General Conditions, Special Conditions, Supplementary Conditions for Federal/State Requirements, plans and specifications and other contract documents, with the bond requirements herein, proposed to furnish all labor, materials, equipment and other necessary items, facilities and services for the proper execution and completion of the subject project in full accordance with the drawings and specifications prepared in accordance with your Advertisement of Bids, instruction to bidders, agreement and all other documents related thereto on file in the office of the Hernando County Procurement Department and if awarded the Contract, to complete said work within the time limits specified for their bid price.

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_		case	COI	11111	

<sup>\*</sup>Response required



# BOARD OF COUNTY COMMISSIONERS HERNANDO COUNTY, FLORIDA SAMPLE WORK AUTHORIZATION AGREEMENT

This Contract, entered into this	day of		, 20	, by and between th	е
Hernando County Board of County	Commissioners, hereafter	r called the COUNT	ΓY, and		
here	inafter called the VENDOF	R/CONTRACTOR.	Owner and	Vendor/Contractor,	in
consideration of the mutual covena	ants hereinafter set forth, a	gree as follow:			

#### CONSTRUCTION SERVICES FOR PROJECTS UNDER \$500K - RFQ NO. 23-T00040/AP

#### PROJECT NAME AND QUOTE NUMBER

#### **ARTICLE 1 – CONTRACT DOCUMENTS**

- 1.01 The Vendor/Contractor shall furnish all labor, equipment and materials and perform the work per Construction Project in strict accordance with the General Conditions, Special Conditions, Supplementary Conditions, Exhibits, Plans, Specifications, and other Contract Documents, all of which are made a part hereof and designated as follows:
  - A. The Contract Documents for ITB 23-T00040/AP consist of the following:

Solicitation-Offer-Award Technical Specifications

Advertisement of Request for Required Forms

Qualifications

Definitions AND NUMBER

Solicitation Document Work Authorization and Required

Documents After Award
General Conditions for Quotes

Special Conditions for Quotes Construction Agreement and Required Documents After Award

Construction Conditions Request for

Scope of Work

Request for Quote Exhibits

Exhibit A – General Requirements and Technical Specifications Exhibit B – Plans/Drawings

Request for Quote - PROJECT NAME

All addenda issued by the County prior to the receipt of Quotes and all supplementary drawings issued after award of the Contract become part of the Contract Document.

Amending and Supplementing Contract Documents:

The Contract Documents may be amended to provide for additions, deletions, and revisions in the work or to modify the terms and conditions thereof by Change Order.

The requirements of the Contract Documents may be supplemented, and minor variations and deviations in the work may be authorized, by one or more of the following ways:

- 1. A Field Order;
- 2. Engineer's approval of a shop drawing or sample; or -
- 3. Engineer's written interpretation or clarification per the provisions described in the Contract Documents.

In resolving such conflicts, errors and discrepancies, the documents shall be given preference in the following order: Agreement, Specifications, Drawings, Solicitation Instructions. Within the specifications the order of preference shall




# HERNANDO COUNTY FLORIDA BOARD OF COUNTY COMMISSIONERS

# COUNTY ADMINISTRATION OFFICE RENOVATION (PHASE 1)

#### COUNTY COMMISSIONERS

DISTRICT 1 - RYAN AMSLER DISTRICT 2 - BRIAN HAWKINS DISTRICT 3 - JOHN ALLOCCO DISTRICT 4 - JERRY CAMPBELL DISTRICT 5 - STEVE CHAMPION

COUNTY ADMINISTRATOR - JEFF RODGERS

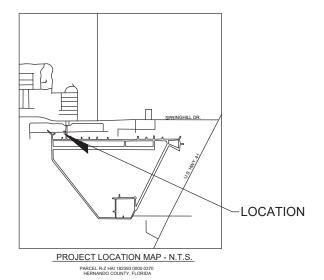

#### DRAWING INDEX

SHEET NUMBER DRAWING DESCRIPTION

G0 COVER

A0 ABBREVIATIONS AND GENERAL NOTES

A1 BUILDING LAYOUT & AREA OF WORK

A2 AREA OF WORK

A3 NEW OVERALL LAYOUT

A4 NEW WALLS

A5 EXISTING REFLECTIVE CEILING

A6 NEW REFLECTIVE CEILING

A7 DETAILS

MO MECHANICAL LEGEND & NOTES

M1 EXISTING MECHANICAL DEMOLITION

M2 NEW MECHANICAL

**E0 ELECTRICAL LEGEND & NOTES** 

E1 EXISTING POWER & DATA

E2 NEW POWER & DATA

E3 EXISTING LIGHTING

**E4 NEW LIGHTING** 

**E5 EXISTING PANEL SCHEDULE** 

LS1 LIFE SAFETY EXITS & CALCULATIONS

HERNANDO COUNTY B.O.C.C FACILITIES DIVISION

1525 EAST JEFFERSON ST. BROOKSVILLE FL. 34601

Project Location:

HERNANDO COUNTY ADMINISTRATION

15470 FLIGHT PATH DR. BROOKSVILLE FL. 34604

Revisions

No:	Description	Date:



Drawing Title

COVER

Drawing Numbe

G0

Drawn by: SDB

#### STANDARD ABBREVIATIONS

#&r⊝® <b>\</b>	- AND - ANGLE - AT - CENTER LINE - DIAMETER OR ROUND - NUMBER OR POUND	EHD EJ EL ELEC ELE EMBED	- ELECTRIC HAND DRYER - EXPANSION JOINT - ELEVATION - ELECTRIC, ELECTRICAL - ELEVATOR - EMBEDMENT	LLH LLV LT LWC LVL LVR	- LONG LEG HORIZONTAL - LONG LEG VERTICAL - LIGHT - LIGHT WEIGHT CONCRETE - LEVEL - LOUVER	REIN REL REM REQ RESIL REV	REINFORCED / REINFORCING RELOCATE REMOVE REQUIRE/REQUIRED RESILIENT REVISION/REVISED
# AB ACC ACOUST ADDL ADDN	- NUMBER OR POUND  - ANCHOR BOLT - ACCESSIBLE - ACOUSTICAL - ADDITIONAL - ADDITION	EMER ENCL EPDM EQ EQUIP ES FW	EMERGENCY     ENCLOSURE     ETHYLENE PROPYLENE DIENE MONOMER     EQUAL     EQUIPMENT     EXPOSED STRUCTURE	M M MAS MAX MED	- METER - MASONRY - MAXIMUM - MEDIUM	RM RO RTD RTU RWL S	- REVISION/REVISED - ROOM - ROUGH OPENING - RATED/RATING - ROOF TOP UNIT - RAIN WATER LEADER
ADDN ADJ AED AFF AFG ALT ALUM	- ADDITION - ADHESIVE - ADJACENT / ADJOINING / ADJUSTABLE - AUTOMATED EXTERNAL DEFIBRILLATOR - ABOVE FINISH FLOOR - ABOVE FINISH GRADE - ALTERNATE - ALLUMINUM	EWC EWH EXH EXIST EXP EXT	- EACH WAY - ELECTRIC WATER COOLER - ELECTRIC WATER HEATER - EXHAUST - EXISTING - EXPANSION - EXPENSION	MEMBR MFR MH MIN MISC MO	- MEMBER - MANUFACTURES - MAN HOLE - MINIMUM - MISCELLANEOUS - MASONRY OPENING	S SA SAF SAN SC SCHED	- SOUTH - SUPPLY AIR - SELF ADHERED FLASHING - SANITARY - SOLID CORE - SCHEDULE
ANCH ANOD AP APC APPROX ASPH	- ANCHOR - ANODIZED - ACCESS PANEL - ACOUSTICAL PANEL CEILING - APPROXIMATE - ASPHALT	FA FAB FAB FD FDN	- FIRE ALARM - FABRIC - FIRE ALARM PANEL - FLOOR DRAIN - FOUNDATION	MR MTD MTL MULL N	- MOISTURE RESISTANT - MOUNTED - METAL - MULLION	SD SECT SF SH SHR SIM SM	- STORM DRAIN - SECTION - SQUARE FEET/FOOT - SPRINKLER HEAD - SIHOWER - SIMILAR - SHEET METAL
ATTN AUTO AV AWT B	- ATTENTION - AUTOMATIC - AVERAGE / AUDIOVISUAL - ACOUSTICAL WALL TREATMENT - BOARD	FE FEC FFEL FHC FIN FLASH	- FIRE EXTINGUISHER - FIRE EXTINGUISHER CABINET - FINISH FLOOR ELEVATION - FIRE HOSE CABINET - FINISH - FI ASHING	N.P.S N/A NC NIC NOM	- NUKETH - NATIONAL PIPE STANDARD - NOT APPLICABLE - NOISE CRITERIA - NOT IN CONTRACT - NOMINAL	SMT SP SPEC SPK SPKR SQ	SURFACE MOUNTED     SPACING     SPECIFICATION/SPECIFIED     SPRINKLER     SPEAKER     SQUARE
BG BITUM BLDG BLKG BOT BRDG	- BOARD - BUMPER GUARD - BITUMINOUS - BUILDING - BLOCKING (WOOD) - BOTTOM - BRIDGING	FLP FLR FRP FT FTG FURR	- FLOOR PATTERN - FLOOR - FIBER REINFORCED PLASTIC - FEET / FOOT - FOOTING - FURRING	NTS O O.A. O.C. OD	- NOT TO SCALE  - OUTSIDE AIR - ON CENTER - OUTSIDE DIAMETER	SS STD STL STOR STRG STRUCT	STAINLESS STEEL     STANDARD     STEEL     STORAGE     STRINGER     STRINGER     STRICTURAL
BRG BRK BRKT BSMT BTWN BUR	- BEARING - BRICK - BRACKET - BASEMENT - BETWEEN - BUILT UP ROOF	FURN FV FWC G GA GALV	- FURNITURE - FIELD VERIFY - FABRIC WALLCOVERING - GAGE, GAUGE - GALVANIZED	OFCI OFF OFOI OHD OPNG OPP	OWNER FURNISHED, CONTRACTOR INSTALLED     OFFICE     OWNER FURNISHED, OWNER INSTALLED     OVERHEAD DOOR     OPENING     OPPOSITE	SUBCAT SUSP SY SYM SYS T	- SUBCATEGORY - SUSPENDED - SQUARE YARD - SYMMETRICAL - SYSTEM
C CAB CB CC CCB CCT	CABINET     CHALKBOARD     CUBICLE CURTAIN     CONCRETE CURBING     CUBICLE CURTAIN TRACK	GB GFRC GL GLAZ GR GRFG	GRAB BAR     GLASS-FIBER REINFORCED CONCRETE     GLASS     GLAZING     GUARDRAIL     CLASS-FIBER REINFORCED GYPSLIM	ORD OVHD OZ P P.A.	- OVERFLOW ROOF DRAIN - OVERHEAD - OUNCE - PUBLIC ADDRESS	T&B T&G T.O.C. T.O.D. T.O.S.	- TOP AND BOTTOM - TONGUE AND GROOVE - TOP OF CONCRETE - TOP OF DECK - TOP OF STEEL
CFMF CG CH CI CIP CJ CL	COLD FORMED METAL FRAMING     CORNER GUARD     CHILLER     CAST IRON     CAST-IN-PLACE     CONTROL JOINT / CONSTRUCTION JOINT	GT GV GWH GYP BD H	- GROUT - GAS VALVE - GAS FIRED WATER HEATER - GYPSUM WALL BOARD	PAV PBD PC PDF PERF PERIM	- PAVING - PARTICLE BOARD - PRECAST CONCRETE - POWER DRIVEN FASTENER - PERFORATED - PERIMETER	T.O.W. TELE TEMP THK THRU TIL	- TOP OF WALL - TELEPHONE / TELECOM - TEMPERATURE - THICKNESS - THROUGH - TILE
CL CLG CLR CMU CNTR CO COL	- CENTER LINE - CELLING - CLEAR - CONCRETE MASONRY UNIT - COUNTER - CLEAN OUT, CASED OPENING - COLUMN	HB HC HDNER HDW HDWD	- HOSE BIB - HANDICAP - HARDENER - HARDWARE - HARDWOOD - HOLLOW METAL	PERP PL PLAM PLAS PLBG PLF	- PERPENDICULAR - PLATE - PLASTIC LAMINATE - PLASTER - PLUMBING - POUNDS PER LINEAR FOOT	TLT TMPD TRANS TYP	- TOILET - TEMPERED - TRANSFORMER - TYPICAL
COMB COMP COMPT CONC CONC CTG COND CONT	- COMBINATION / COMBINED - COMPRESSIBLE - COMPARTMENT - CONCRETE - CONCRETE COATING - CONDITION	HORIZ HR HT HTG HVAC	- HORIZONTAL - HAND RAIL - HAND RAIL - HEIGHT - HEATING - HEATING, VENTILATING, AND AIR CONDITIONING	PLYWD PNL PNT POL PR PRFFAB	- PLYWOOD - PANEL - PAINT OR PAINTED - POLISHED - PAIR - PREFABRICATED	UNFIN UNO UON URNL V	UNFINISHED     UNLESS NOTED OTHERWISE     UNLESS OTHERWISE NOTED     URINAL
CONT CONTR CORR CPT CR CRL CRS	- CONTINUOUS - CONTRACTOR - CONTRACTOR - CORRIDOR - CARPET - CLOSET ROD - CRASH RAIL - COLD-ROLLED STEEL	I ID IF IN INCL INSUI	- INSIDE DIAMETER / INSIDE DIMENSION - INSIDE FACE - INCHINCHES - INCLUDED - INSI IN ATION	PROJ PSF PT PTN PVC	- PROJECT PER SQUARE FOOT - POUNDS PER SQUARE FOOT - PRESSURE TREATED - PARTITION - POLYVINYL CHLORIDE	VAR VB VCT VERT VEST VIF	- VARIES - VAPOR BARRIER - VINYL COMPOSITION TILE - VERTICAL - VESTIBULE - VERTIBULE
CT CTR CUH CUV CW D	- CERAMIC TILE - CENTER - CABINET UNIT HEATER - CABINET UNIT VENTILATION - CURTAIN WALL / COLD WATER - CURTAIN WALL / COLD WATER	INT INV J JT	- INTERIOR - INVERT	QT QTY R R	- QUARRY TILE - QUANTITY - RISER	VT VWC UNFIN UNFIN	- VINYL TILE - VINYL WALL COVERING - UNFINISHED - UNFINISHED
D DC DCL DET DETN DF	- DEEP / DEPTH / PENNY - DISPLAY CASE - DOOR CLOSER - DETAIL - DETENTION - DRINKING FOUNTAIN	KD KO L L	- KNOCKED DOWN - KNOCK OUT - LONG, LENGTH - LAMINATE	RA RAD RB RBR RCP RD	- RETURN AIR - RADIUS - RESILIENT BASE - RUBBER - REFLECTIVE CEILING PLAN - ROOF DRAIN	W W/ W/I W/O WC WD	- WEST / WIDTH / WIDE - WITH - WITHIN - WITHOUT - WATER CLOSET - WOOD
DIA DIM DN DP DR DS DWG	- DIAMETER - DIMENSION - DOWN - DECORATIVE PANEL - DOOR - DOWN SPOUT - DRAWINGS(S)	LAV LB L.F. LH LKR LL	- LAVATORY - POUNDS - LINEAL FOOT - LEFT HAND - LOCKER - LIVE LOAD, LOW LEVEL	RE REC RECPT REF REFR REG	- REINFORCED - RECESSED - RECEPTACLE - REFERENCE - REFRERATION - REGISTER	WDW WM WT WV WWF WWM	- WINDOW - WIRE MESH - WEIGHT - WATER VALVE - WELDED WIRE FABRIC - WELDED WIRE MESH
E E EA	- EAST - EACH						

#### GENERAL NOTES

- 1. EXISTING SITE INFORMATION AS SHOWN AND DESCRIBED IN THESE DOCUMENTS HAS BEEN DEVELOPED FROM FIELD SURVEY INFORMATION BY OWNER. THIS IN NO WAY RELIEVES THE CONTRACTOR OF RESPONSIBILITY TO DETERMINE EXISTING CONDITIONS, CONSTRUCTION DETAILS. MEASUREMENTS, ETC. CONTRACTOR SHALL REVIEW EXISTING CONDITIONS AND DETERMINE APPROPRIATE COORDINATION OF NEW WORK AS DESCRIBED PRIOR TO COMMENCEMENT OF ANY DEMOLITION OR OTHER WORK
- 2. ALL WORK PERFORMED MUST COMPLY WITH THE REGULATIONS AND ORDINANCES OF THE VARIOUS GOVERNMENTAL AGENCIES HAVING JURISDICTION OVER THE WORK
- 3. THIS DRAWING HAS GENERAL INFORMATION, NOT ALL MAY APPLY TO THIS PROJECT
- 4. IF AT ANY TIME, THE CONTRACTOR DISCOVERS A CONDITION WHICH CONFLICTS WITH THE DRAWING OR DISCOVERS AN UNCLEAR OR MISLEADING DIRECTIVE IN DRAWING , THE CONTRACTOR MUST BRING THE ISSUE IMMEDIATELY TO THE ATTENTION OF THE OWNER
- 5. MAINTAIN FREE, SAFE, AND APPROVED MEANS OF EGRESS IN AND OUT OF PROJECT LOCATION AND EXISTING OCCUPIED BUILDING
- 6. GENERAL CONTRACTOR SHALL COORDINATE REQUIREMENTS OF ALL TRADES TO ALLOW FOR TIMELY INCLUSION IN THE WORK ALL REQUIRED ITEMS SO NOT TO DELAY THE WORK OR THE WORK OF ANY SUBCONTRACTOR.
- 7. ALL WORK INDICATED ON THIS DRAWING ARE THE SOLE RESPONSIBILITY OF THE CONTRACTOR UNLESS OTHERWISE NOTED
- 8. USE OF SITE FOR ANY CONSTRUCTION STAGING OR OTHER OPERATIONS SHALL BE COORDINATED WITH OWNER
- 9. CONTRACTOR TO USE BEST MANAGEMENT PRACTICES TO CONTROL DUST INSIDE BUILDING AND OUTSIDE OF BUILDING AND SURROUNDING AREA DURING PROJECT, ALL TRUCKS HAULING DEBRIS FROM PROJECT SITE OR MATERIAL TO PROJECT SITE SHALL BE EQUIPPED WITH THE MEANS TO COVER LOADS. CONTRACTOR AND SUB-CONTRACTORS WORK VEHICLES SHALL BE CHECKED BEFORE LEAVING SITE THAT NO DEBRIS, MATERIAL, TOOLS, ETC. COULD FALL OFF ONTO PARKING LOT AN BE LEFT BEHIND.
- 10. CONTRACTOR IS RESPONSIBLE FOR PROTECTING FLOORING IN ALL AREAS INSIDE AND OUTSIDE OF PROJECT LIMITS
- 11. CONTRACTOR TO REMOVE EXISTING AIR FILTER FROM ACG GRILLS OR AIR HANDLER UNIT AND GIVE TO OWNER CONTRACTOR TO SUPPLY PLEATED AIR FILTER FOR AIC UNITS DURING CONSTRUCTION. FILTER TO BE CHECK PERIODICALLY DURING PROJECT AND REPLACE WITH NEW PLEATED FILTER IF DIRTY, CONTRACTOR WILL BE RESPONSIBLE FOR CLEANING AIR HANDLER EVAPORATOR COIL IF FOUND CLOGGED WITH DUST/DEBRIS FROM CONSTRUCTION PROJECT.

#### PROJECT DESCRIPTION

CONSTRUCT NEW WALLS, RE-LOCATE MODIFY OR ADD POWER AND LIGHTING, REMOVE EXISTING PLENUM, DUCTS & GRILLS. INSTALL NEW PLENUM DUCTS & GRILLS. ADD DATA CHASES IN WALLS. INSTALL CEILING WALL MOULDING AND RELOCATE OR INSTALL 2 & 4 FOOT CEILING GRID TES'S

#### HERNANDO COUNTY B.O.C.C FACILITIES DIVISION

1525 EAST JEFFERSON ST. BROOKSVILLE FL. 34601

Project Location:

## HERNANDO COUNTY ADMINISTRATION

15470 FLIGHT PATH DR. BROOKSVILLE FL. 34604

#### Revisions:

No:	Description	Date:



Drawing Title:

ABBREVIATIONS & GENERAL NOTES

Drawing Number:

Scale: 1/16" = 1

A0
Drawn by: SDB


**GENERAL LEGEND** 


KEY NOTES


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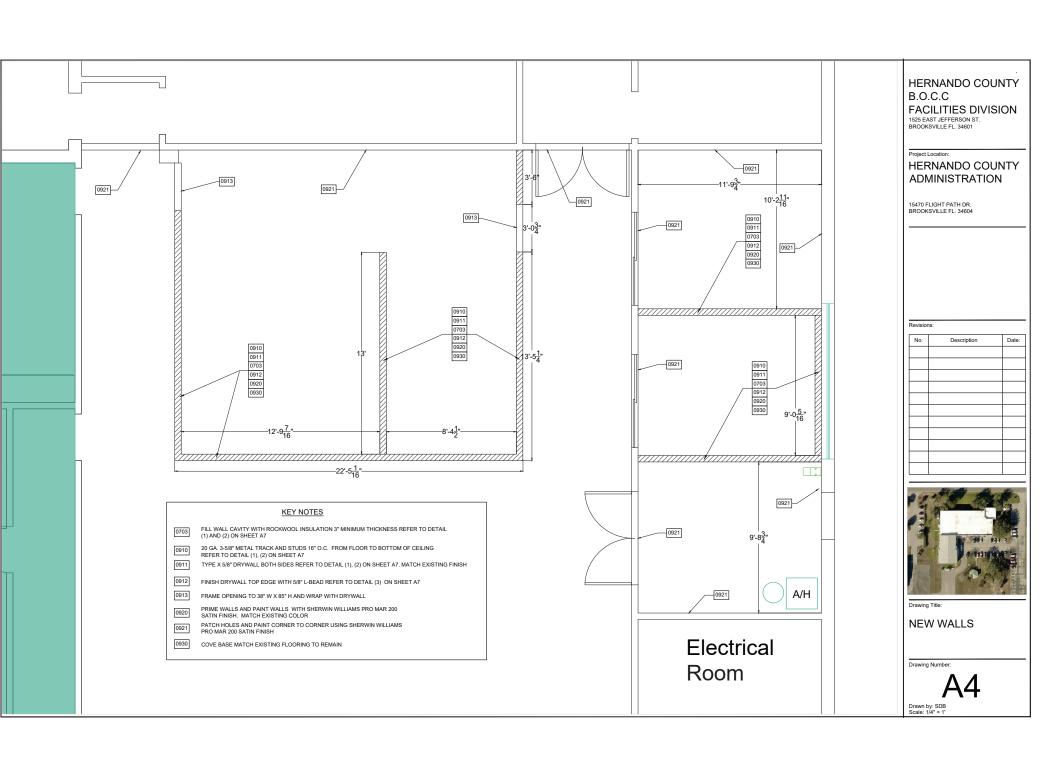
NOTE: SOME SYMBOLS SHOWN ON THIS LEGEND MAY NOT PERTAIN TO THIS PROJECT


	EXISTING WALL NEW WALL	STEEL COLUM
	DOOR	
###	ROOM NUMBER	
###	DOOR NUMBER	




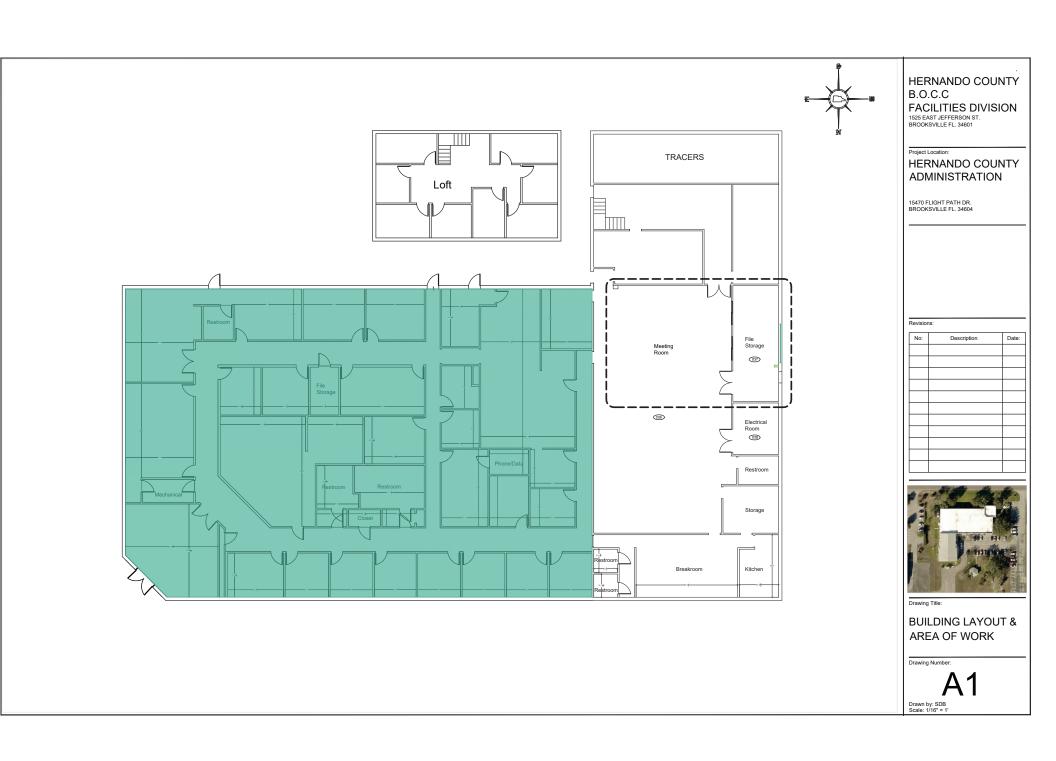


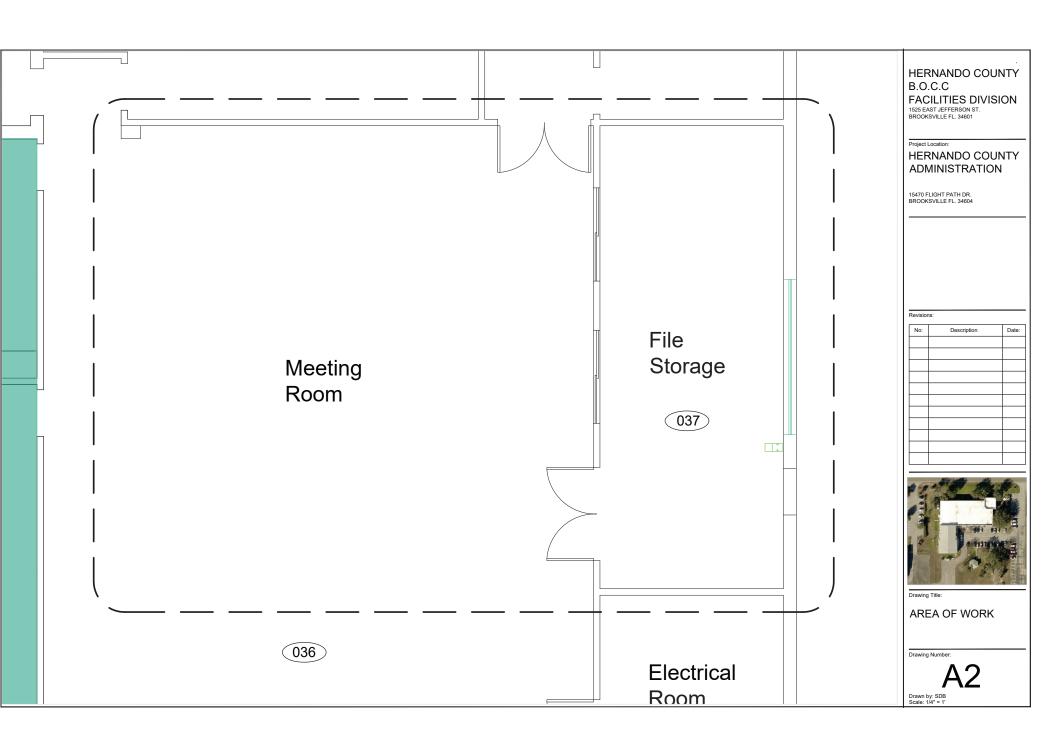


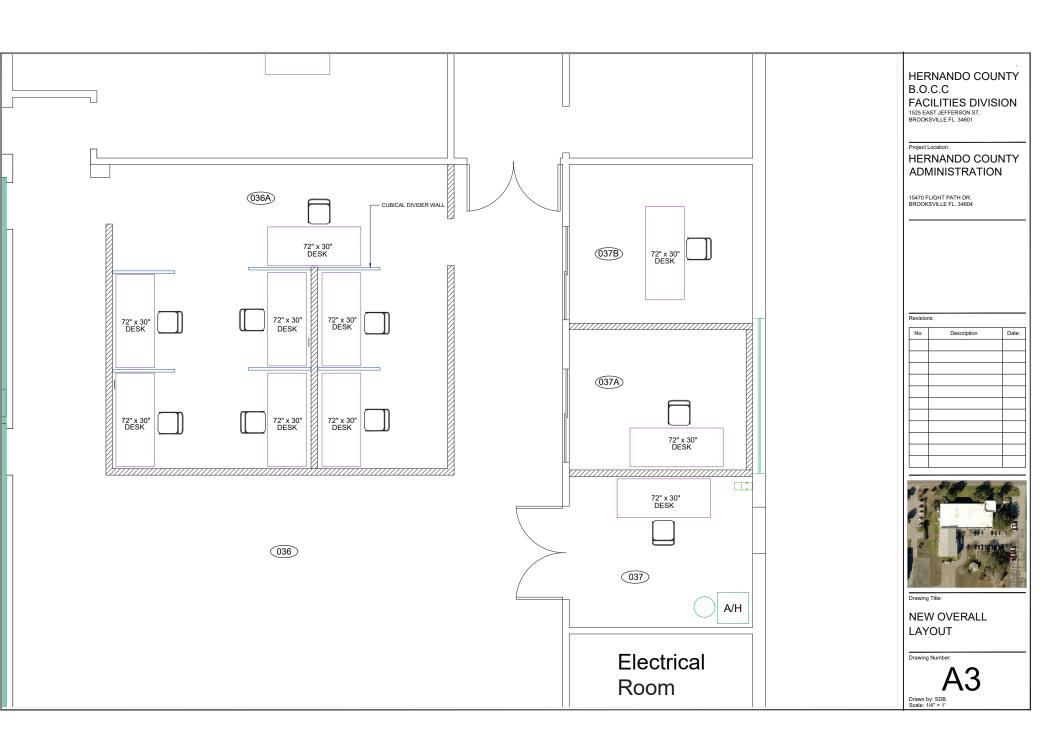


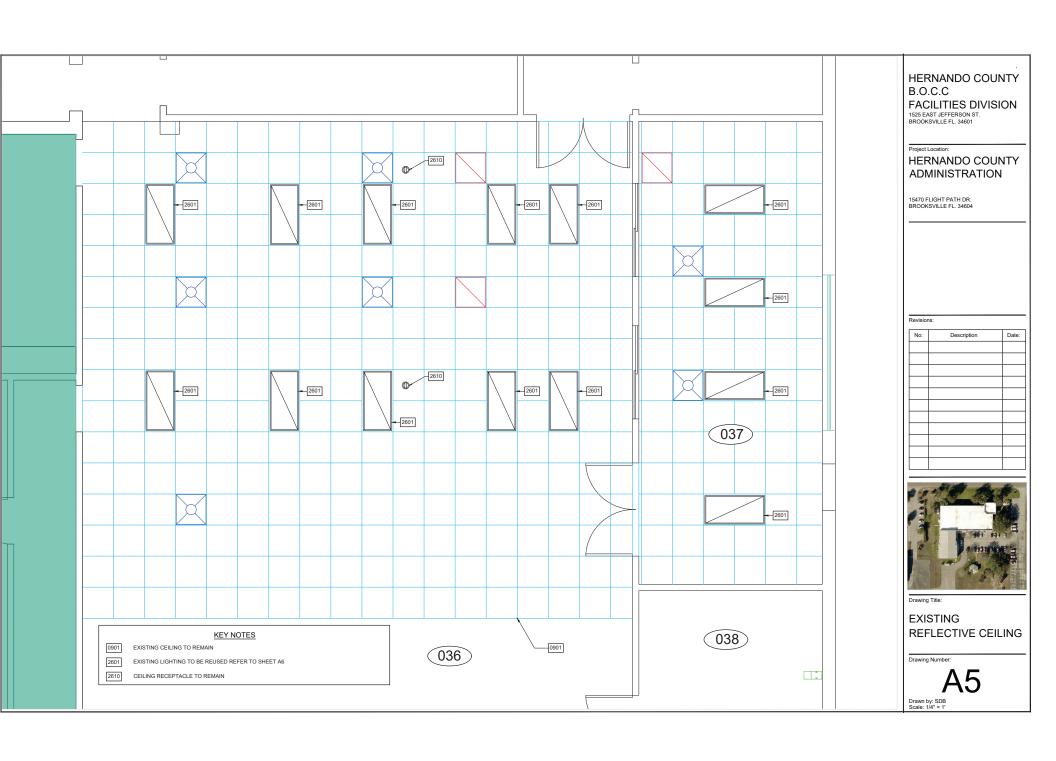


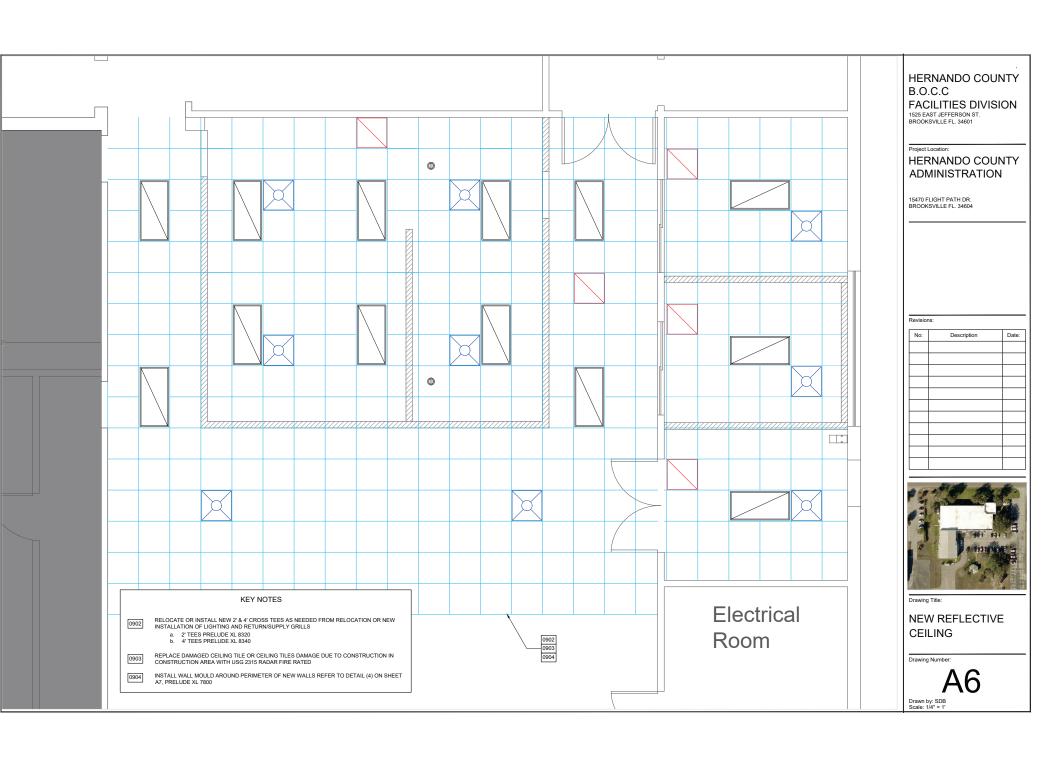

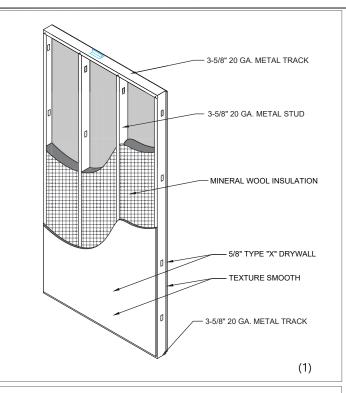

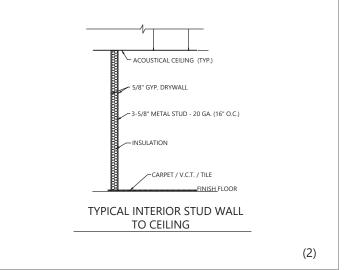

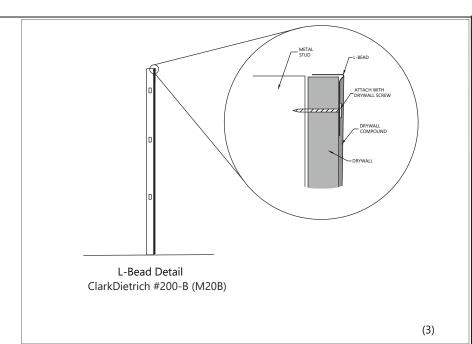

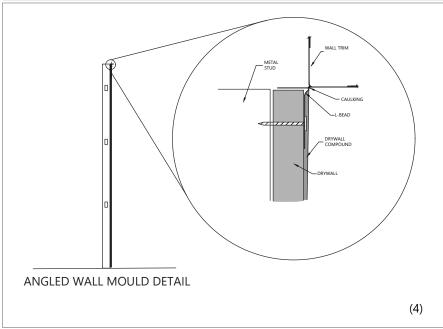

## HERNANDO COUNTY B.O.C.C FACILITIES DIVISION 1525 EAST JEFFERSON ST. BROOKSVILLE FL. 34601

Project Location:

#### HERNANDO COUNTY **ADMINISTRATION**

15470 FLIGHT PATH DR. BROOKSVILLE FL. 34604

#### Revisions:

No:	Description	Date:



**DETAILS** 

Drawing Number:

Drawn by: SDB Scale: 1/4" = 1'

#### **HVAC ABBREVIATIONS**

AFD	- ADJUSTABLE FREQUENCY DRIVE	MBH
AFF	- ABOVE FINISH FLOOR	MCA
AFR	- ABOVE FINISH ROOF	MOCP
AUH	- AIR HANDLING UNIT	MOD
AP	- ACCESS PANEL	NC
BOP	- BOTTOM OF PIPE	NO
BHP	- BRAKE HORSEPOWER	NTS
BTU	- BRITISH THERMAL UNIT	OA
CL	- CENTER LINE	OAL
CFM	- CUBIC FEET PER MINUTE	PSI
CD	- CEILING DIFFUSER	PVC
CT	- COOLING TOWER	RA
CV CU	- CONSTANT AIR VOLUME - CONDENSING UNIT	RHC RPM
DN	- DOWN	RS/I
EAT	- ENTERING AIR TEMPERATURE	RTU
ESP	- EXTERNAL STATIC PRESSURE	SA
EWT	<ul> <li>ENTERING WATER TEMPERATURE</li> </ul>	SP
FB	- FILTER BOX	TSP
FCU	- FAN COIL UNIT	UNO
FD	- FIRE DAMPER	V/PH
FF.	- FINAL FILTER	VAV
FLA FPM	- FULL LOAD AMPS - FEET PER MINUTE	VFD
KW	- KII OWATT	
LAT	- I FAVING AIR TEMPERATURE	
IWT	- LEAVING WATER TEMPERATURE	
LD	- LINEAR DIFFUSER	

- THOUSAND BTUs PER HOUR
- MINIMUM CIRCUIT AMPS
- MAXIMUM OVER CURRENT PROTECTION - MOTOR OPERATED CONTROL DAMPER
- NORMALLY CLOSED - NORMALLY OPEN
- NOT TO SCALE
- OUTDOOR AIR - OUTSIDE AIR LOUVER
- POUNDS PER SQUARE INCH
- POLYVINYL CHLORIDE PIPE
- RETURN AIR
- REHEAT COIL REVOLUTIONS PER MINUTE
  - REFRIGERANT SUCTION AND LIQUID LINES ROOF TOP UNIT
- SUPPLY AIR
- STATIC PRESSURE
- TOTAL STATIC PRESSURE
- UNLESS NOTED OTHERWISE
- VOLTS / PHASE
- VARIABLE AIR VOLUME
- VARIABLE FREQUENCY DRIVE

### **HVAC LEGEND**

	CEILING SUPPLY DIFFUSER
	CEILING RETURN
	CEILING EXHAUST
①	THERMOSTAT / TEMPERATURE SENSOR
$\oplus$	HUMIDISTAT / HUMIDITY SENSOR
©	CARBON DIOXIDE SENSOR
4	ADJUSTABLE DAMPER
	EXISTING FLEX DUCT
HIIIIIIIIIIIIIII	FLEX DUCT
16X12	DUCT BOARD, FIRST DIMENSION IS WIDTH
16X12	METAL DUCT, FIRST DIMENSION IS WIDTH
$\wedge$	DUCT BOARD TRI-BOX, DUCT SIZE TO DETERMINE

#### **GENERAL HVAC NOTES**

- 1. CONNECTION TO EQUIPMENT SHALL BE VERIFIED WITH MANUFACTURE'S CERTIFIED DRAWINGS. TRANSITIONS TO ALL EQUIPMENT SHALL BE VERIFIED AND PROVIDED FOR EQUIPMENT FURNISHED.
- 2. DIMENSIONS SHALL BE FIELD-VERIFIED AND COORDINATED PRIOR TO PROCUREMENT OR FABRICATION. COORDINATE THE WORK WITH OTHER TRADES INVOLVED. FIELD MODIFICATIONS SUCH AS OFFSETS IN PIPING OR DUCTWORK (INCLUDING DIVIDED DUCTWORK) NEEDED DUE TO OBSTRUCTIONS OR INTERFERENCE SHALL BE PROVIDED AT NO ADDITIONAL COST. FOR PROJECTS INVOLVING RENOVATION, COORDINATE NEW WORK WITH EXISTING ELEMENTS SUCH AS THE BUILDING STRUCTURE AND ARCHITECTURAL FEATURES, SPRINKLER PIPE, LIGHTS, PLUMBING, AND ELECTRICAL CONDUIT
- 3. DUCT CONSTRUCTION SHALL BE IN ACCORDANCE WITH THE LATEST EDITION OF THE SMACNA DUCT CONSTRUCTION
- 4. PROVIDE AIR TURNING VANES IN ALL 90 DEGREE RECTANGULAR DUCT ELBOWS
- 5. DUCT SIZES AND ALL OPENINGS THROUGH BUILDING CONSTRUCTION SHALL SUIT EQUIPMENT FURNISHED
- 6 LOCATE THERMOSTATS, TEMPERATURE SENSORS, HUMIDISTAT, AND HUMIDITY SENSORS AT 48" ABOVE FINISHED FLOOR UNITESS. NOTED OTHERWISE. COORDINATE LOCATIONS WITH OTHER EQUIPMENT, FURNITURE, AND DOOR SWING
- 7. ALL EQUIPMENT, DUCTWORK, ETC. SHALL BE SUPPORTED. PROVIDE ADDITIONAL SUPPORTS AS REQUIRED TO PROVIDE A VIBRATION-FREE, RIGID INSTALLATION.
- 8. ALL DUCT SIZES SHOWN ARE INSIDE CLEAR DIMENSIONS.
- 9. DAMPERS AND INSIDES OF DUCTS VISIBLE THROUGH GRILLS, REGISTERS AND DIFFUSERS SHALL BE PAINTED FLAT BLACK.
- 10. REFER TO TYPICAL DETAILS FOR PIPING AND INSTALLATION OF EQUIPMENT.
- 11. TRAPPED CONDENSATE DRAINS FROM ALL MECHANICAL EQUIPMENT SHALL BE PROVIDED FOR PROPER DRAINAGE TO SUIT EQUIPMENT FURNISHED.
- 12. ACCESS PANELS IN DUCTWORK AND CEILING SHALL BE PROVIDED WHERE REQUIRED FOR OPERATION, BALANCING OR MAINTENANCE OF ALL MECHANICAL EQUIPMENT.
- 13. ALL DUCTWORK AND PIPING IS SHOWN SCHEMATICALLY. PROVIDE ALL TRANSITIONS, TURNING VANES, ELBOWS, FITTING, ETC., TO ALLOW SMOOTH FLOWS. ALL SPLIT DUCT FITTINGS SHALL TRANSITION TO FULL SIZE OF THE SUM OF BOTH BRANCHES. UPSTREAM OF SPLIT
- 14. VERIFY FINISH WITH OWNER PRIOR TO PURCHASING GRILLES, REGISTERS, DIFFUSERS, LOUVERS AND OTHER AIR
- 15. PROVIDE FLEXIBLE DUCT CONNECTIONS ON ALL DUCTWORK CONNECTING TO EACH FAN. AIR HANDLING UNIT. AND FAN COIL UNITS.
- 16. PROVIDE TRANSITIONS AT DIFFUSER NECKS AS REQUIRED TO MATCH SIZES OF FLEX DUCTS TO BE CONNECTED.
- 17. ALL EQUIPMENT, DUCTWORK, ETC., TO BE REMOVED SHALL REMAIN PROPERTY OF THE OWNER OR DISPOSED OF LEGALLY, AS DIRECTED BY OWNER
- 18. MAINTAIN CLEARANCE OF A MINIMUM OF 6" BETWEEN DUCTWORK, PIPING, EQUIPMENT, ETC., AND ALL FIRE RATED AND FIRE/SMOKE RATED PARTITIONS, TO ALLOW FOR INSPECTIONS OF FIRE RATED WALLS.
- 19. LOCATED ALL OUTSIDE AIR INTAKES A MINIMUM OF 10' CLEAR FROM ALL PLUMBING VENTS AND EXHAUST AIR DISCHARGE LOCATIONS.
- 20. DUCT RUNOUTS TO DIFFUSERS SHALL MATCH THE SIZE OF THE DIFFUSER NECK. FLEX DUCT RUNOUTS SHALL BE A MAXIMUM OF 6' IN LENGTH, SUPPORT ALL RUNOUTS WITH APPROPRIATE HANGERS, FLEX DUCT SHALL NOT SAG OR BE CRIMPED
- 21. THE CONDENSATE DRAIN LINE SHALL HAVE A TRAP AT THE AIR HANDLING UNIT. TRAP SHALL BE FULL SIZE OF UNIT CONNECTION. PROVIDE CLEAN OUTS IN ALL CHANGES OF DIRECTION. MINIMUM PITCH 1/8" PER FOOT. CONDESATE DRAIN SHALL RUN TO CONDENSATE OUTSIDE OR EXISTING DRYWELL. INSULATE ALL INTERIOR CONDENSATE PIPING WITH FLEXIBLE UNICELLULAR FOAM (ARMAFLEX OR EQUIVALENT) INSULATION TO PREVENT SWEATING. CONDESATE DRAIN LINES AND TRAPS IN MECHANICAL ROOMS SHALL BE INSULATED COPPER OR PVC AND SHALL BE RIGIDLY SUPPORTED.
- 22. AIR HANDLING UNITS SHALL HAVE AN AUXILIARY DRAIN PAN 3" LARGER THAN UNIT EACH WAY, DRAIN PAN SHALL HAVE A FLOAT SWITCH TO DE-ENERGIZE THE AHU IN EVENT OF A CONDENSATE OVERFLOW CONDITION.
- 23. AIR HANDLING UNITS SHALL BE PLACED ON A 1/4" NEOPRENE PAD WITHIN AN AUXILIARY DRAIN PAN
- 24. CONDENSING UNITS SHALL BE PLACED ON A CONCRETE PAD 6" THICK BY 6" LARGER EACH WAY THAN UNIT.
- 25. CONCRETE SLAB/PAD IS TO HAVE NO CONTACT WITH ANY METAL PORTION OF THE EQUIPMENT OR THAT EQUIPMENT SUPPORT. PROVIDE 1/4" THICK RED OR BLACK, RUBBER PAD UNDER THE ENTIRE METAL SURFACE INTENDED TO REST ON THE CONCRETE PAD.
- 26. ALL EXTERIOR FASTENERS, ANCHORS, SUPPORTS, AND MOUNTING HARDWARE SHALL BE NOT DIPPED GALVANIZED OR STAINLESS STEEL.
- 27. PRIOR TO SUBSTANTIAL COMPLETION, A COMPLETED CERTIFIED TEST AND BALANCE REPORT SHALL BE SUBMITTED TO OWNER FOR REVIEW.
- 28. ALL THERMOSTAT/WALL SENSORS SHALL BE LABELED WITH THE AH/CU MARK OF THE ITEM BEING CONTROLLED
- 29 ALL ADDITIONAL REQUIREMENTS WILL BE NOTED IN PLANS OR SPECIFICATIONS.

HERNANDO COUNTY BOCC **FACILITIES DIVISION** 1525 EAST JEFFERSON ST. BROOKSVILLE FL. 34601

Project Location:

#### HERNANDO COUNTY **ADMINISTRATION**

15470 FLIGHT PATH DR. BROOKSVILLE FL. 34604

#### Revisions


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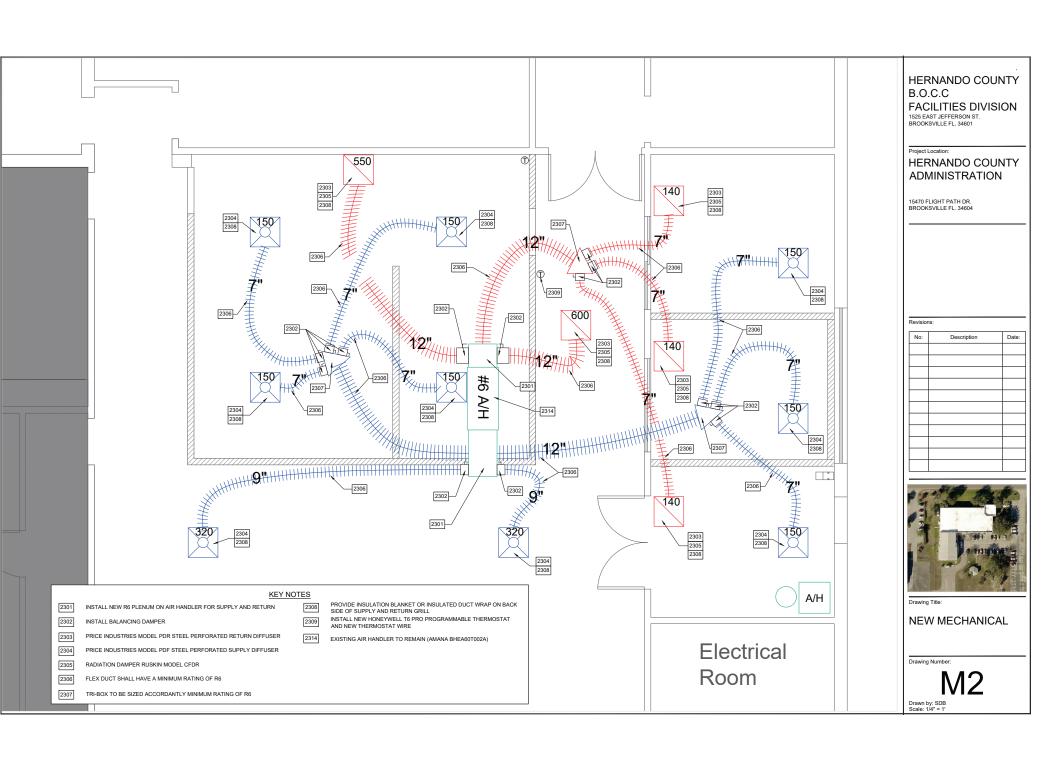


MECHANICAL LEGEND & NOTES

Drawn by: SDB Scale: 1/4" = 1

SOME GENERAL MECHANICAL NOTES MAY NOT PERTAIN TO THIS PROJECT



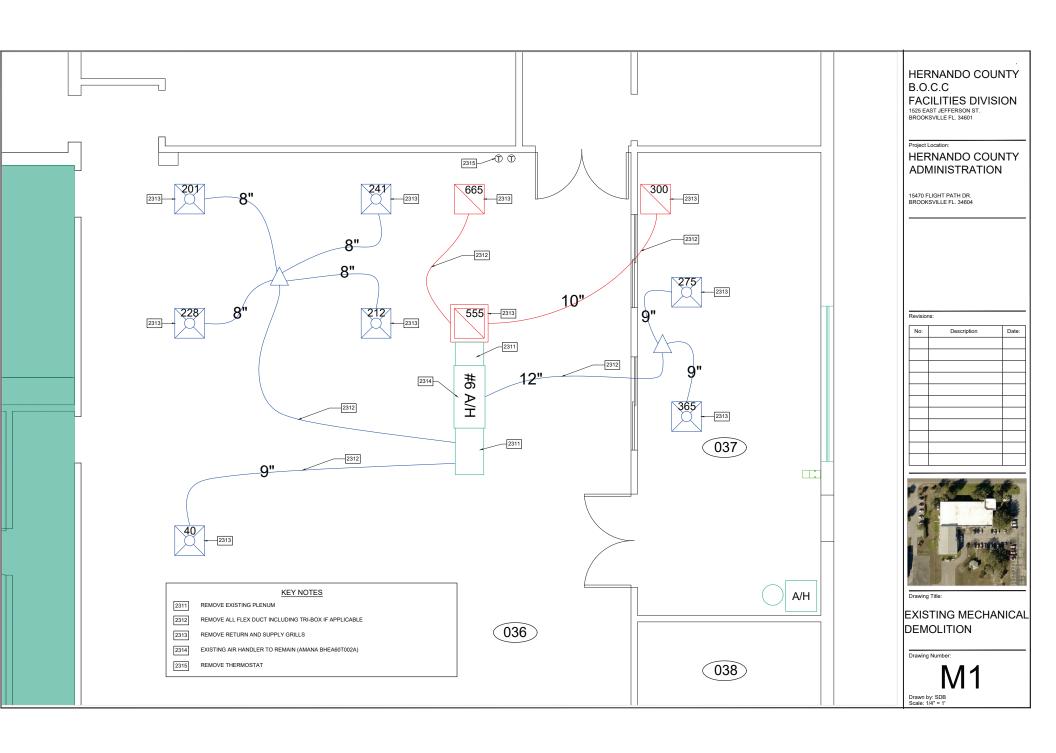

#### **ELECTRICAL ABBREVIATIONS**

A/C	- AIR CONDITIONING		
		KW	- KILOWATT
AC	- ALTERNATING CURRENT	KWH	- KILOWATT HOURS
ABV CLG	- ABOVE CEILING	LBS	- POUNDS
ADA	- AMERICANS WITH DISABILITIES ACT	LED	- LIGHT EMITTING DIODE
AF	- AMPERE FRAME	I.P.	- LIGHTNING PROTECTION
AFF	- ABOVE FINISH FLOOR		- LIGHT
AFG	- ABOVE FINISH GRADE	LT	
	- AIR HANDI ER LINIT	LTG	- LIGHTING
AHU		MAX	- MAXIMUM
AIC	- AMPERE INTERRUPTING CAPACITY	MCA	- MINIMUM CIRCUIT AMPS
AL	- ALUMINUM	MCB	- MAIN CIRCUIT BREAKER
AMP	- AMPERE	MCC	- MOTOR CONTROL CENTER
ANSI	- AMERICAN NATIONAL STANDARD INSTITUTE	MDP	- MAIN SERVICE DISTRIBUTION PANEL
ASA	- AMERICAN STANDARDS ASSOCIATION	MIC	- MICROPHONE
AT	- AMPERE TRIP	MIN	- MINIMUM
ATS	- AUTOMATIC TRANSFER SWITCH	MLO	- MAIN LUGS ONLY
AUX	- AUXILIARY	MOCP	- MAXIMUM OVERCURRENT PROTECTION
AWG	- AMERICAN WIRE GUAGE	MSB	- MAIN SWITCHBOARD
BC	- BARE COPPER	MTD	- MOUNTED
BIL	- BASIC IMPULSE LEVEL	MTG	- MOUNTING
BAS	- BUILDING AUTOMATION SYSTEM	MTR	- MOTOR
BMS	- BUILDING MANAGEMENT SYSTEM	MTS	- MANUEL TRANSFER SWITCH
BRK	- BREAKER	MVA	- MEGA VOLT AMPS
C	- CONDUIT OR RACEWAY	N	- NEUTRAL
CAB	- CABINET	NC	- NORMALLY CLOSED
CKT	- CIRCUIT	NEC	- NATIONAL ELECTRICAL CODE
CBM	- CERTIFIED BALLAST MANUFACTURES	NEMA	- NATIONAL ELECTRICAL MANUFACTURES ASSOCIATION
CATV	- CABLE TELEVISION	NENA	- NATIONAL FIRE PROTECTION ASSOCIATION
CCTV	- CLOSED CIRCUIT TELEVISION	NF NF	- NON-FUSED
CLEC	- CLOCK EQUIPMENT CABINET	NL	- NON-LINEAR
COAX	- COAXIAL CABLE	NO	- NORMALLY OPEN
COND		OL	- OVERLOAD
	- CONDUCTOR	OSHA	- OCCUPATIONAL SAFETY & HEALTH ADMINISTRATION
CONN	- CONNECTION	P	- POLE
CPU	- CENTRAL PROCESSING UNIT	PB	- PULL BOX
CT	- CURRENT TRANSFORMER	PF	- POWER FACTOR
CU	- COPPER	PNL	- PANEL
DC	- DIRECT CURRENT	PR	- PAIR
DEG	- DEGREE	PRI	- PRIMARY
DE	- DEMAND FACTOR		
DISC	- DISCONNECT	PWR	- POWER
DISC SW	- DISCONNECT SWITCH	REC	- RECEPTACLE
DISC SW	- DISCONNECT SWITCH	RGS	- RIGID GALVANIZED STEEL CONDUIT
DPST	- DOWN - DOUBLE POLE SINGLE THROW	RLA	- RUNNING LOAD AMPERES
EDH	- ELECTRIC DUCT HEATER	RMS	- ROOT-MEANS-SQUARE
EMT	- ELECTRIC METALLIC TUBING	RPM	- REVOLUTIONS PER MINUTE
EO	- ELECTRICALLY OPERATED	RTU	- ROOF TOP UNIT
FOI	- END OF LINE	SCA	- SHORT CIRCUIT AMPERES
ETR	- EXISTING TO REMAIN	SD	- SMOKE DETECTOR
FWC	- ELECTRIC WATER COOLER	SEC	- SECONDARY
	- FIRE ALARM	S/N	- SOLID NEUTRAL
FA FAAP	- FIRE ALARM ANNUNCIATOR PANEL	SPD	- SURGE PROTECTIVE DEVICE
		SPKR	- SPEAKER
FATC	- FIRE ALARM TERMINAL CABINET	SPST	- SINGLE POLE SINGLE THROW
FBC FCU	- FLORIDA BUILDING CODE	SS	- STAINLESS STEEL
FLA	- FAN COIL UNIT	SST	- SOLID STATE TRIP
FPU FPU	- FULL LOAD AMPERES - FAN POWERED UNIT	STD	- SHORT TIME TRIP
	- FEET OR FOOT	SW	- SWITCH
FT		SWBD	- SWITCHBOARD
GF	- GROUND FAULT	SWGR	- SWITCH GEAR
GFA	- GROUND FAULT ALARM	TEL	- TELEPHONE
GFCI	- GROUND FAULT CIRCUIT INTERRUPTER	TRANS	- TRANSFORMER
GND	- GROUND	TV	- TELEVISION
HP	- HORSEPOWER	TYP	- TYPICAI
HOA	- HAND-OFF-AUTOMATIC	UG	- UNDERGROUND
HORIZ	- HORIZONTAL	UON	
IC	- INTERCOM		- UNLESS OTHERWISE NOTED
IEEE	- INSTITUTE OF ELECTRICAL AND ELECTRONIC ENGINEERS	UL	- UNDERWRITERS LABORATORIES
IN	- INCHES	VA	- VOLT AMPERE
ΪŤ	- INSTANTANEOUS TRIP	W	- WIRE
JB	- JUNCTION BOX	WP	- WEATHER PROOF
KV	- KILOVOLT		
KVA	- KILOVOLT AMPERES		

#### **GENERAL ELECTRICAL NOTES**

NOTE: SOME GENERAL NOTES SHOWN MAY NOT PERTAIN TO THIS PROJECT

- 1. ALL ELECTRICAL WORK SHALL MEET ALL OF THE REQUIREMENTS OF THE FLORIDA BUILDING CODE (FBC) 8TH EDITION (2023). THE CODE INCLUDES THE 2020 FBC BUILDING, MECHANICAL, PLUMBING, FUEL GAS AND ENERGY CONSERVATION VOLUMES, 2017 NATIONAL ELECTRIC CODE, AND 7TH EDITION OF THE FLORIDA FIRE PREVENTION COL
- 2. IT IS THE CONTRACTOR'S RESPONSIBILITY TO VISIT THE SITE AND VERIFY THE EXITING CONDITIONS TO GAIN KNOWLEDGE OF THE SCOPE OF WORK INVOLVED.
- 3. "PROVIDE" SHALL MEAN "FURNISH AND INSTALL"
- 4. IN GENERAL THESE DRAWINGS ARE SCHEMATIC IN NATURE AND SHOULD NOT BE SCALED. IT SHALL NOT BE INTENT OF THESE PLANS AND JOR SPECIFICATION TO SHOW EVERY MINOR DETAIL OF CONSTRUCTION. PROVIDE ALL ITEMS NECESSARY FOR A COMPLETE AND OPERATIONAL SYSTEM.
- 5. ELECTRICAL INSTALLATION SHALL BE COORDINATED WITH ALL OTHER TRADES. NO COST SHALL BE ASSOCIATED WITH ILL-TIMED INSTALLATION INCLUDING ANY REPAIRS OR REPLACEMENTS.
- 6. ALL CONDUIT AND BOXES SHALL BE CONCEALED UNLESS OTHERWISE NOTED. ALL CONDUIT RUNS ARE SCHEMATIC IN NATURE. EXACT ROUTING TO BE DETERMINED IN THE FIELD UNLESS OTHERWISE NOTED.
- 7. APPLY A BITUMASTIC COATING FOR ALL CONDUITS PENETRATING FLOOR SLABS FROM BELOW GRADE.
- $8.\,\mathsf{PROVIDE}\,\mathsf{ALL}\,\mathsf{REQUIRED}\,\mathsf{PULL}\,\mathsf{BOXES},\mathsf{JUNCTION}\,\mathsf{BOXES},\mathsf{ETC}.\,\mathsf{FOR}\,\mathsf{A}\,\mathsf{COMPLETE}\,\mathsf{INSTALLATION}.$
- 9. PATCH, REPAIR AND REPAINT ALL WALLS THAT HAVE BEEN DAMAGED DUE TO ELECTRICAL ROUGH-IN. REMOVE ANY UNUSED CONDUIT AND WIRE.

  10. PROVIDE RIFE-STOPPING AT ALL FIRE WALL PENETRATIONS. USE A UL. APPROVED SYSTEM LISTED FOR THE ASSOCIATED INSTALLATION.
- 10. PROVIDE FIRE-SLOPPING AT ALL FIRE WALL PENE TRATIONS, USE: A UL. APPROVED SYSTEM LISTED FOR THE ASSOCIATED INSTALLATION.
- 11. ALL CIRCUITS SHALL CONTAIN A SEPARATE, GREEN, COPPER GROUNDING CONDUCTOR.
- 12. ALL RECEPTACLES SHALL HAVE A GROUND TERMINAL.
- 13. WHEN REUSING OR EXTENDING EXISTING CIRCUITS, VERIFY ALL CIRCUIT NUMBERS AND VERIFY ANY EXISTING LOAD. CIRCUITS MAY BE PICKED UP AT AN EXISTING JUNCTION BOX IF AVAILABLE RATHER THAN PROVIDING A SEPARATE HOMERUN TO A PANEL.
- 14. PANEL BOARDS SHALL BE ACCURATELY LABELED TO IDENTIFY FINAL CIRCUIT NUMBER UTILIZED, THEIR LOAD AND LOCATION.
- 15. PROVIDE SEPARATE NEUTRAL CONDUCTOR FOR ALL 120V SINGLE POLE CIRCUITS PER NEC ARTICLE 210.4. BREAKER HANDLE TIES ARE UNACCEPTABLE.
- 16. PROVIDE FIRE RETARDANT U.L. APPROVED SEALANT ON ALL PENETRATIONS OF FIRE RATED PARTITIONS, WALLS AND STRUCTURAL SLABS.

#### **ELECTRICAL LEGEND**

$= \square$	CONNECTED TO EMERGENCY CIRCUIT		BICATOTI CONTENTED, OVER 240 VOETS, SORT AGE MODITED
\$	SINGLE POLE SWITCH		BRANCH CIRCUIT BOARD, OVER 240 VOLTS, FLUSH MOUNTED
<b>\$</b> <sub>3</sub>	THREE-WAY SWITCH	$\overline{}$	BRANCH CIRCUIT BOARD, UNDER 240 VOLTS, SURFACE MOUNTED
\$ <sub>4</sub>	FOUR-WAY SWITCH		BRANCH CIRCUIT BOARD, UNDER 240 VOLTS, FLUSH MOUNTED
$\ominus$	SINGLE RECEPTACLE		
$\rightleftharpoons$	DUPLEX RECEPTACLE	24/7	LED OR FLUORESCENT FIXTURE 2'X4' LAY-IN  (DIAGONAL HALF SHADE INDICATE FIXTURE TO EMERGENCY CIRCUIT OR PROVIDE INTEGRAL
<b>=</b>	TWO DUPLEX RECEPTACLE (QUAD) WITH COMMON PLATE		EMERGENCY BATTERY PACK ) NOTE: 24/7 INDICATES LIGHT TO BE ON AT ALL TIMES
$\rightleftharpoons$	DUPLEX RECEPTACLE MOUNTED ABOVE CEILING	24/7	LED OR FLUORESCENT FIXTURE 2'X2' LAY-IN  (DIAGONAL HALF SHADE INDICATE IXTURE TO EMERGENCY CIRCUIT OR PROVIDE INTEGRAL EMERGENCY BATTERY PACK INOTE: 247 MIDICATES LIGHT TO BE ON AT ALL TIMES
	TWP DUPLEX RECEPTACLE (QUAD) MOUNTED ABOVE CEILING		LINEAR LED. FLUORESCENT WALL OR CEILING MOUNTED
$\bigcirc$	DUPLEX RECEPTACLE EACH RECEPTACLE ON SEPARATE CIRCUIT		,
$\rightleftharpoons$	SPLIT WIRE CONTROLLED DUPLEX RECEPTACLE		EXTERIOR PEDESTRIAN SIDEWALK BOLLARD OR POST-TOP LIGHT FIXTURE
$\blacksquare$	GFCI RECEPTACLE; "WP" INDICATES CAST METAL "IN-USE" WATERPROOF COVER, WEATHER-RESISTANT LISTED	0	LED, FLUORESCENT, HID, RECESSED, PENDANT OR SURFACE CEILING
#=	TWO GFCI RECEPTACLE (QUAD) WITH COMMON COVER PLATE	Ю	LED, FLUORESCENT, HID WALL MOUNT
•	DUPLEX RECEPTACLE, CEILING MOUNTED	4	EMERGENCY TWIN-HEAD LIGHT WITH INTEGRAL BATTERY PACK, WALL MOUNTED
<b>(1)</b>	TWO DUPLEX RECEPTACLE, CEILING MOUNTED	⊗	EXIT LIGHT CEILING MOUNTED (DIRECTIONAL ARROWS AS INDICATED, SHADED QUADRANT INDICATES FACE(S) OF FIXTURE)
Φ	FLOOR BOX WITH DUPLEX RECEPTACLE WITH APPROPRIATE FLANGE	H <b>⊗</b> E	EXIT LIGHT WALL MOUNTED (DIRECTIONAL ARROWS AS INDICATED, SHADED QUADRANT INDICATES FACE(S) OF FIXTURE)
<b>•</b>	FLOOR BOX, TWO DUPLEX RECEPTACLE (QUAD) WITH APPROPRIATE FLANGE	<u> </u>	DISCONNECT SWITCH, SIZE/FUSE/# OF POLES
$\bigcirc \frac{50}{240}^2$	RECEPTACLE, 1PH-125/240V, AMP/VOLT/POLE	T	TRANSFORMER
<b>(</b>	SPECIAL PURPOSE RECEPTACLE, NEMA CONFIGURATION AS NOTED	ATS	AUTOMATIC TRANSFER SWITCH
①	JUNCTION BOX		
P	POWER POLE JUNCTION BOX IN CEILING	GEN	GENERATOR
$\triangle$	DATA WALL BOX (NUMBER IN SYMBOL INDICATES NUMBER OF PORTS)	(H/L1) - (15)	LIGHTING CIRCUIT (HIGH OR LOW VOLTAGE-PANEL NUMBER) (CIRCUIT NUMBER)
	DATA CEILING BOX (NUMBER IN SYMBOL INDICATED NUMBER OF PORTS)	(H/L1) - (15)	POWER CIRCUIT (HIGH OR LOW VOLTAGE-PANEL NUMBER) (CIRCUIT NUMBER)
•	TELEPHONE	(EMH/L1) - (15)	EMERGENCY CIRCUIT (HIGH OR LOW VOLTAGE-PANEL NUMBER) (CIRCUIT NUMBER
1	TELEVISION WALL BOX		WALL MOUNTED EXHAUST FAN
PB	PULL BOX		
œ	CARD READER		

CAMERA

#### HERNANDO COUNTY B.O.C.C FACILITIES DIVISION

1525 EAST JEFFERSON ST. BROOKSVILLE FL. 34601

Project Location:

## HERNANDO COUNTY ADMINISTRATION

15470 FLIGHT PATH DR. BROOKSVILLE FL. 34604

#### Revisions:

No:	Description	Date:




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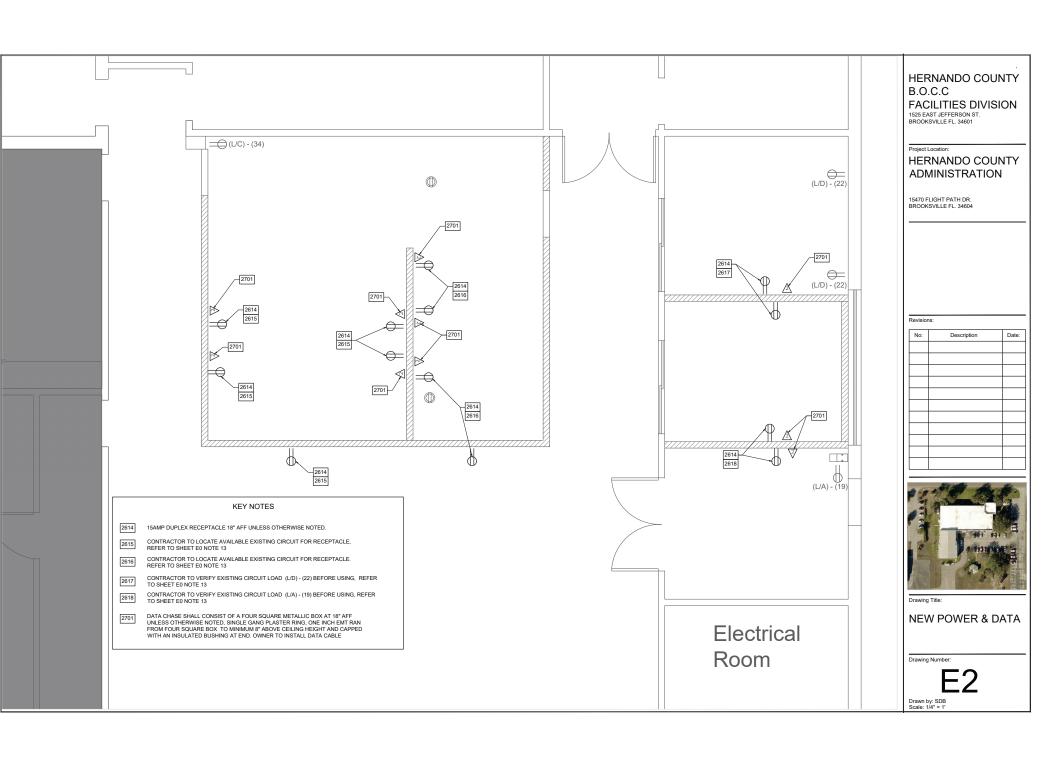
ELECTRICAL LEGEND & NOTES


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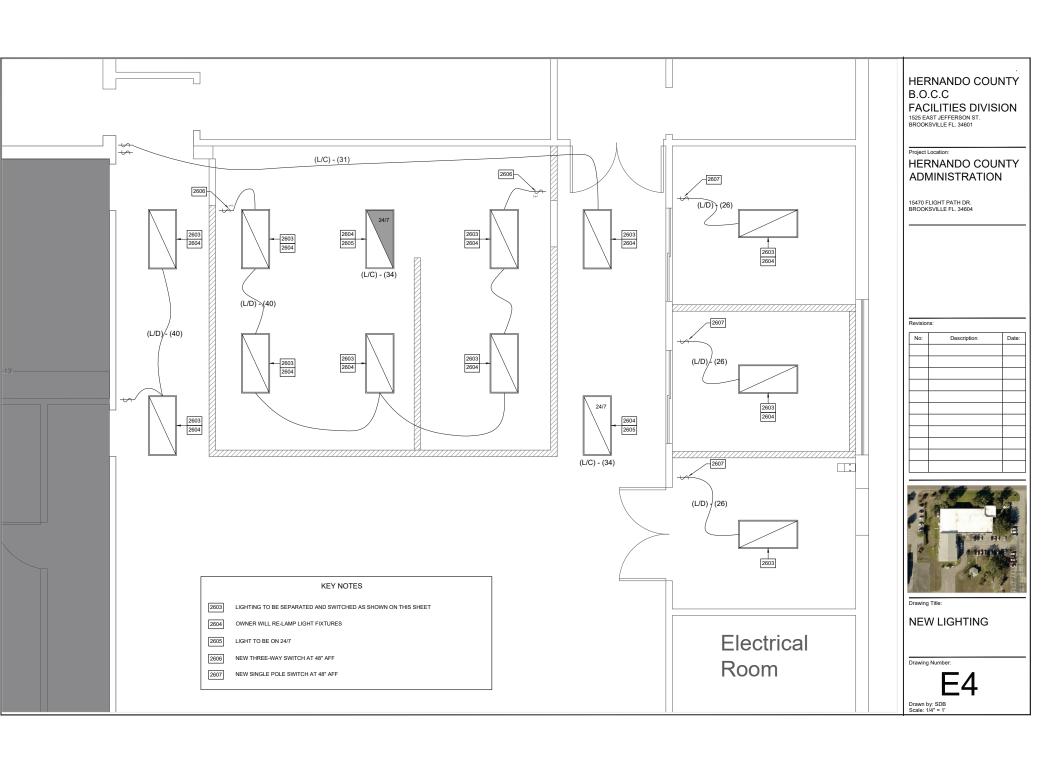
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Drawn by: SDB Scale: 1/4" = 1'







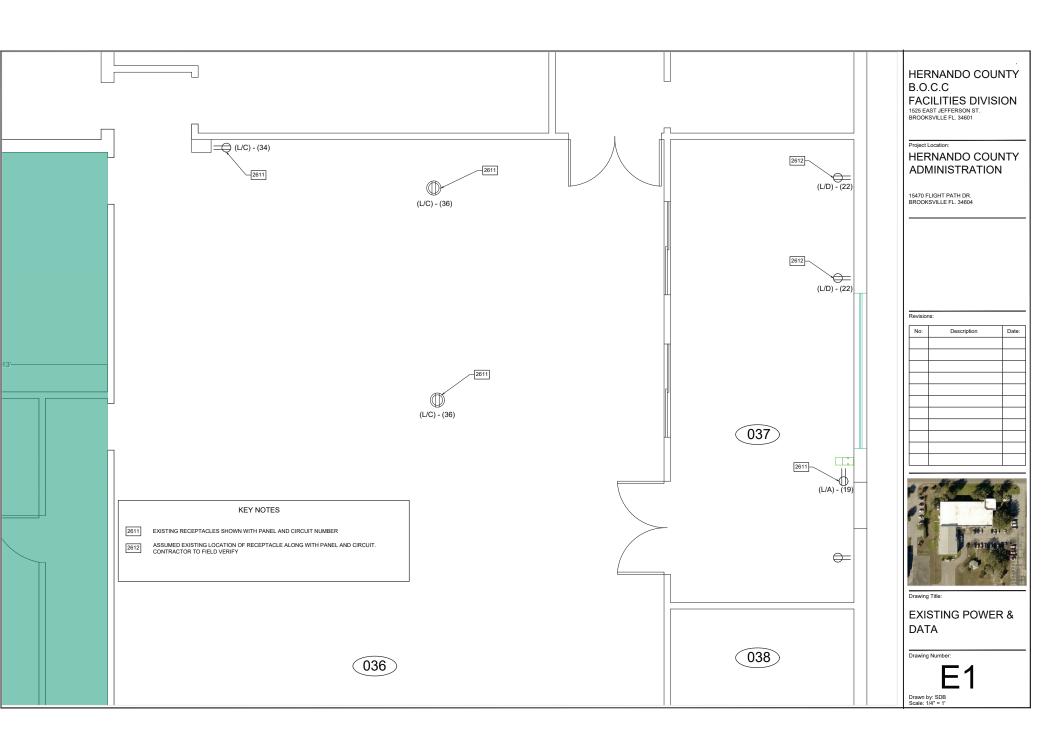

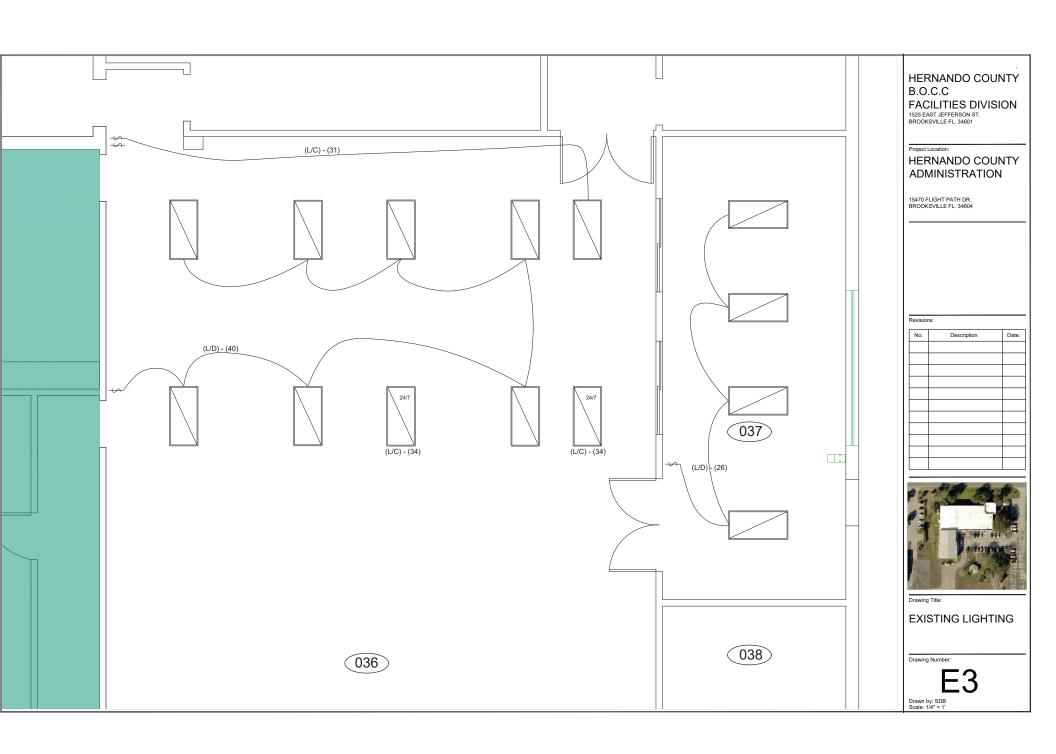	Panel Rating (AMPS): 200	PAN	EL	A VOLTAGE/PHASE/WIRES: 120/2	VOLTAGE/PHASE/WIRES: 120/208/3/4	
C K T	DESCRIPTION	TRIP	C K T	DESCRIPTION	TRIP	
1	WH		2	AHU #1	40	
3	WH	30	4	AHU #1		
5	CEILING	20	6	SPACE	30	
7	SPARE	60	8	SPACE	20	
9	SPARE	00	10	SPACE	20	
11	RECEPTACLE	20	12	SPACE	20	
13	RECEPTACLE	20	14	SPACE	20	
15	RECEPTACLE & LIGHTS	20	16	MICROWAVE	20	
17	R	20	18	HOT ROOM	30	
19	RECEPTACLE & LIGHTS	20	20	HOT ROOM	30	
21	RECEPTACLE	20	22	A/C	60	
23	OUTSIDE LIGHTS & WAREHOUSE LIGHTS	20	24	A/C	60	
25	SUB		26	COMPRESSOR		
27	SUB	80	28	COMPRESSOR	40	
29	SUB		30	COMPRESSOR		

	Panel Rating (AMPS): 200	PAN	PANEL C VOLTAGE/PHASE/WIRES: 120/20			
C K T	DESCRIPTION	TRIP	C K T	DESC	CRIPTION	TRIP
1	AHU #3		2	UP STAIRS A/C		60
3	AHU #3	35	4	UP STAIRS A/C		7 60
5	AHU #3		6	A/C #1		
7	AHU #4		8	A/C #1		40
9	AHU #4	35	10	A/C #1		7
11	AHU #4		12	NEW A/H		30
13	A/C #5		14	NEW A/H		7 30
15	A/C #5	40	16	A/C		60
17	A/C #5		18	A/C		00
19	A/C #3		20	AHU		
21	A/C #3	35	22	AHU		35
23	A/C #3		24	AHU		
25	RECEPTACLE & LIGHTS	20	26	UNKNOWN		40
27	RECEPTACLE & LIGHTS	20	28	UNKNOWN		7 40
29	RECEPTACLE & LIGHTS	20	30	LIGHTS & RECEPTACLE	(TANDEM)	20
31		20	32	UNKNOWN	(TANDEM)	20
33	AIR HANDLER		34	UNKNOWN		20
35	AIR HANDLER	30	36	UNKNOWN		20
37	CONDENSER		38	UNKNOWN		20
39	CONDENSER	50	40	UNKNOWN	(TANDEM)	20
41	CONDENSER	7 30	42			

## HERNANDO COUNTY B.O.C.C FACILITIES DIVISION 1525 EAST JEFFERSON ST. BROOKSVILLE FL. 34601

Project Location:

#### HERNANDO COUNTY **ADMINISTRATION**

15470 FLIGHT PATH DR. BROOKSVILLE FL. 34604

ı	Revision

No:	Description	Date:




Drawing Title:

**EXISTING PANEL** SCHEDULE

Drawing Number:

Drawn by: SDB Scale:

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C K T	DESCRIPTION	TRIP	C K T	DE	SCRIPTION	TRIP	
1	AHU #6		2	AHU #7			
3	AHU #6	35	4	AHU #7		35	
5	AHU #6		6	AHU #7			
7	A/C #6	]	8	A/C #7			
9	A/C #6	35	10	A/C #7		35	
11	A/C #6		12	A/C #7			
13	WALL A/C	20	14	SOLDER MACHINE #1		20	
15	WALL A/C	20	16	SOLDER MACHINE #1		20	
17	RECEPTACLE & LIGHTS	20	18	UNKNOWN	(TANDEM)	20	
19	NEW TEST STATION		20	BLANK			
21	NEW TEST STATION	20	22	UNKNOWN		15	
23	NEW TEST STATION	1	24	UNKNOWN	(TANDEM)	20	
25	R&D	20	26	RECEPTACLE	(TANDEM)	20	
27	R&D	20	28	UNKNOWN		20	
29	R&D	20	30	UNKNOWN		20	
31	LIGHTS	20	32	R&D			
33	UNKNOWN	20	34	R&D		50	
35	SUB PANEL Z	50	36	R&D			
37	SUB PANEL Z	50	38	UNKNOWN	(TANDEM)	20	
39	UNKNOWN (TANDEM)	20	40	UNKNOWN	(TANDEM)	20	
41			42				

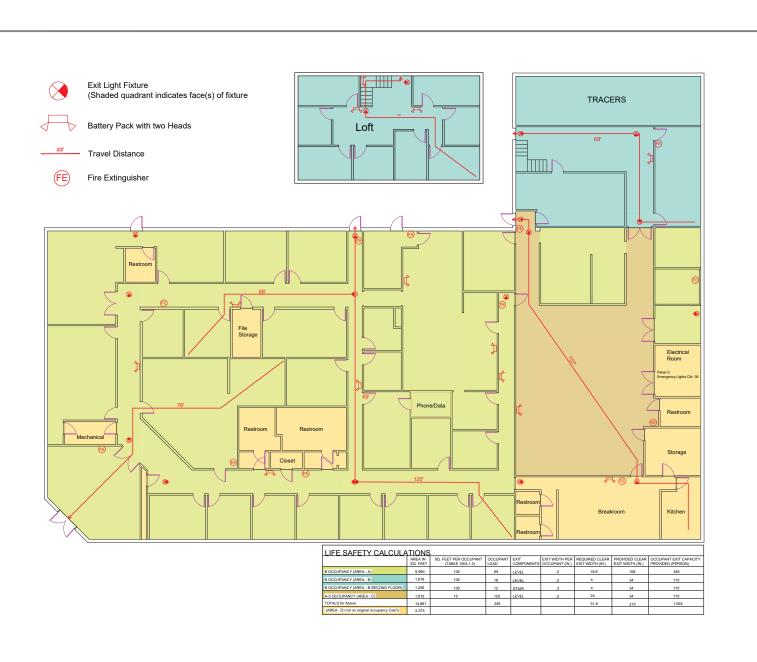

## HERNANDO COUNTY B.O.C.C FACILITIES DIVISION 1525 EAST JEFFERSON ST. BROOKSVILLE FL. 34601

Project Location:

#### HERNANDO COUNTY **ADMINISTRATION**

15470 FLIGHT PATH DR. BROOKSVILLE FL. 34604

#### Revisions:

No:	Description	Date:



#### LIFE SAFETY EXISTS & CALCULATIONS

Drawing Number:

Drawn by: SDB Scale: 1/16" = 1'

be as follows: Addenda, General Conditions, Technical Specifications. Figure dimensions on drawings shall govern over scale dimensions, and the detailed drawings shall govern over general drawings. Any work that may reasonably be inferred from the specifications or drawings as being required to produce the intended result shall be supplied whether or not it is specifically called for. Work materials or equipment described in words which so applied have a well-known technical or trade meaning shall be deemed to refer to such recognized standards. In case of conflict the more stringent requirements shall take precedence and govern.

The Vendor/Contractor shall take no advantage of any error or omission in the plans or of any discrepancy between the plans and specifications, and the Engineer shall make such interpretation as may be deemed necessary for the fulfillment of the intent of the plans and specifications as construed by him and his decision shall be final.

All provisions required by law to be inserted in this Contract, whether actually inserted or not.

Exhibits to this Agreement (as follows):

- 1. Vendor/Contractor's Quote
- 2. Documentation submitted by Vendor/Contractor after to Notice of Award:
  - a. Insurance Certificate
- B. The following which may be delivered or issued on or after the Effective Date of the Agreement and are not attached hereto:
  - 1. Notice to Proceed
  - 2. Change Order(s)
- C. The documents listed in this Article are attached to this Agreement (except as expressly noted otherwise).
- D. There are no Contract Documents other than those listed in this Article.
- E. The Contract Documents may only be amended, modified, or supplemented as stated in Paragraph 33.

#### **ARTICLE 2 - THE ENGINEER**

2.01 Engineer in the administration of this Contract and any references to the Engineer or the Professional shall be deemed to mean INSERT ENGINEER OF RECORD NAME, for the plans and specifications. INSERT PROJECT MANAGER NAME OR PROJECT MANAGER'S SUPERVISOR NAME will act as the Owner's representative, assume all duties and responsibilities, and have the rights and authority assigned to Engineer in the Contract Documents in connection with the completion of the work in accordance with their respective scope of work and the Contract Documents.

#### **ARTICLE 3 - CONTRACT TIMES**

- **3.01** Time of the Essence:
  - A. All time limits for completion and readiness for final payment as stated in the Contract Documents are of the essence of the Contract.
- 3.02 <u>Days to Achieve Substantial Completion and Final Payment:</u>
  - A. Vendor/Contractor agrees that the work will be substantially complete within **days to substantial completion** (000) calendar days after the commencement date indicated in the Notice to Proceed and ready for final payment within **days to final completion** (000) calendar days after the date indicated on the Notice to Proceed.
- **3.03** Liquidated Damages:

Vendor/Contractor and Owner agree for each consecutive calendar day that the work remains incomplete after the Contract date established for Substantial Completion and/or Final Completion, the County will retain from the compensation otherwise to be paid to the Vendor/Contractor the sum of **INSERT AMOUNT FOR LIQUIDATED DAMAGES** (\$\_\_\_\_\_\_). This amount is the minimum measure of damages the County will sustain by failure of the Vendor/Contractor to complete all remedial work, correct deficient work, clean up the project and other miscellaneous tasks as required to complete all work specified.

#### **ARTICLE 4 - CONTRACT PRICE**

4.01

A. For all work other than Unit Price Work, a Lump Sum of:										
			(wo	ords)		(\$) (figure)				
			All specific cash allowances are included in the above price and have been computed in accordance with Paragraph 34.2.2.							
B. For all Unit Price Work, an amount equal to the sum of the established unit price for each separately identified item of Unit Price Work times the estimated quantity of that item as indicated in this Paragraph:							tified			
	As provided in Paragraph 34.3, estimated quantities are not guaranteed, and determinations of actual quantities and classifications are to be made by Owner Designated Representative as provided in Paragraph 34.3. Unit prices have been computed as provided in Paragraph 34.3.									
		•		PRICE WORK						
ITEN	VI	QTY	DESCRIPTION	PART NO	UNIT PRICE	EXTENDED PRICE				
						\$				
ESTI	MAT	ED TO	OTAL OF ALL UNIT PRICE WORK	\$		\$()				
					(use words)	(figure)				
ARTIC	LE	5 – PA	YMENT PROCEDURES							
5.01	.01 Submittal and Processing of Payments:									

Owner shall pay Vendor/Contractor for completion of the work in accordance with the Quote an amount in current

funds equal to the sum of the amounts determined pursuant to the Paragraphs below:

## **5.02** Progress Payments; Retainage:

A. Owner shall make progress payments on account of the Contract Price on the basis of Vendor/Contractor's Applications for Payment not later than the time periods established by applicable provisions of the Florida Prompt Payment Act, Part VII, Ch. 218.735, F.S. (current version), during performance of the work as provided in Paragraphs below. All such payments will be measured by the Schedule of Values (and in the case of Unit Price Work based on the number of units completed) or, in the event there is no schedule of values, as provided in the General Requirements:

A. Vendor/Contractor shall submit Applications for Payment in accordance with Paragraph 37.2.1. Applications for Payment will be processed by Owner Designated Representative as provided in the Contract Documents.

- 1. Progress payments will be made in an amount equal to the percentage indicated below but, in each case, less the aggregate of payments previously made and less such amounts as Owner Designated Representative may determine or Owner may withhold, including but not limited to liquidated damages, in accordance with the Contract Documents:
  - a. Ninety-five (95%) of work completed (with the balance being retainage); and

b. Ninety-five (95%) of cost of materials and equipment not incorporated in the work (with the balance being retainage).

#### **5.03** Final Payment:

- A. Upon receipt of the final Application for Payment accompanied by Owner Designated Representative's recommendation of payment in accordance with Paragraph 37.7.1, Owner shall pay Vendor/Contractor the remainder of the Contract Price as recommended by Owner Designated Representative, less any sum Owner is entitled to set off against Owner Designated Representative's recommendation, including but not limited to liquidated damages.
- B. Final Payment, constituting the entire unpaid balance of the Contract Sum, shall be paid by the Owner to the Vendor/Contractor when the work has been completed, the Contract fully performed, and a final Certificate for Payment has been issued by the Owner Designated Representative.

#### **ARTICLE 6 - INTEREST**

**6.01** All monies not paid when due shall bear interest at the maximum legal rate.

#### ARTICLE 7 - VENDOR/CONTRACTOR'S REPRESENTATIONS

- 7.01 In order to induce Owner to enter into this Agreement Vendor/Contractor makes the following representations:
  - A. Vendor/Contractor has examined and carefully studied the Contract Documents and the other related data identified in the Bid Documents.
  - B. Vendor/Contractor has visited the site and become familiar with and is satisfied as to the general, local, and site conditions that may affect cost, progress, and performance of the work.
  - C. Vendor/Contractor is familiar with and is satisfied as to all federal, state, and local laws and regulations that may affect cost, progress, and performance of the work.
  - D. Vendor/Contractor does not consider that any further examinations, investigations, explorations, tests, studies, or data are necessary for the performance of the work at the Contract Price, within the Contract Times, and in accordance with the other terms and conditions of the Contract Documents.
  - E. Vendor/Contractor is aware of the general nature of work to be performed by Owner and others at the site that relates to the work as indicated in the Contract Documents.
  - F. Vendor/Contractor has correlated the information known to Vendor/Contractor, information and observations obtained from visits to the site, reports and drawings identified in the Contract Documents, and all additional examinations, investigations, explorations, tests, studies, and data with the Contract Documents.
  - G. Vendor/Contractor has given Engineer written notice of all conflicts, errors, ambiguities, or discrepancies that Vendor/Contractor has discovered in the Contract Documents, and the written resolution thereof by Engineer is acceptable to Vendor/Contractor.
  - H. The Contract Documents are generally sufficient to indicate and convey understanding of all terms and conditions for performance and furnishing of the work.

#### **ARTICLE 8 - MISCELLANEOUS**

#### **8.01** Terms:

A. Terms used in this Agreement will have the meanings stated in the Contract Documents.

#### **8.02** Assignment of Contract:

A. No assignment by a party hereto of any rights under or interests in the Contract will be binding on another party hereto without the written consent of the party sought to be bound; and, specifically but without limitation,

monies that may become due and moneys that are due may not be assigned without such consent (except to the extent that the effect of this restriction may be limited by law), and unless specifically stated to the contrary in any written consent to an assignment, no assignment will release or discharge the assignor from any duty or responsibility under the Contract Documents.

### 8.03 Successors and Assigns:

A. Owner and Vendor/Contractor each binds itself, its partners, successors, assigns, and legal representatives to the other party hereto, its partners, successors, assigns, and legal representatives in respect to all covenants, Agreements, and obligations contained in the Contract Documents.

#### 8.04 Severability:

- A. Any provision or part of the Contract Documents held to be void or unenforceable under any Law or Regulation shall be deemed stricken, and all remaining provisions shall continue to be valid and binding upon Owner and Vendor/Contractor, who agree that the Contract Documents shall be reformed to replace such stricken provision or part thereof with a valid and enforceable provision that comes as close as possible to expressing the intention of the stricken provision.
- 8.05 This Agreement may be executed in several counterparts, each of which shall be an original and all of which shall constitute but one and the same instrument.

#### **ARTICLE 9 - CONTRACT PAYMENT**

9.01	The County agrees to pay the Ve	endor/Contractor for the faithful	performance under this	Contract for the agreed
	amount of	Dollars (\$	_) and is based on the lu	imp sum prices contained
	herein and subject to additions or	deductions as modified.		

IN WITNESS WHEREOF, Owner and Vendor/Contractor have signed this Agreement in two (2) copies. All portions of the Contract Documents have been signed, initialed, or identified by Owner and Vendor/Contractor.

OWNER: HERNANDO COUNTY BOARD OF COUNTY COMMISSIONERS	VENDOR/CONTRACTOR			
Ву:	By:			
Name: ELIZABETH NARVERUD	Name:			
Title: CHAIR	Title:			
[CORPORATE SEAL]	[CORPORATE SEAL]			
Attest: Douglas A. Chorvat, Jr.	Attest:			
Title: Clerk of Circuit Court & Comptroller	Title:			
Address for giving notices:	Address for giving notices:			
15470 Flight Path Dr.				
Brooksville, FL 34604				
	Agent for service of process:			
	(If Vendor/Contractor is a corporation or a partnership, attach evidence of authority to sign.)			