
Freedom Ridge Subdivision **Conditional Plat** Parcel Key Numbers 1302922, 424231, 4242222, 1428440 Spring Hill, Hernando County, FL, 34613

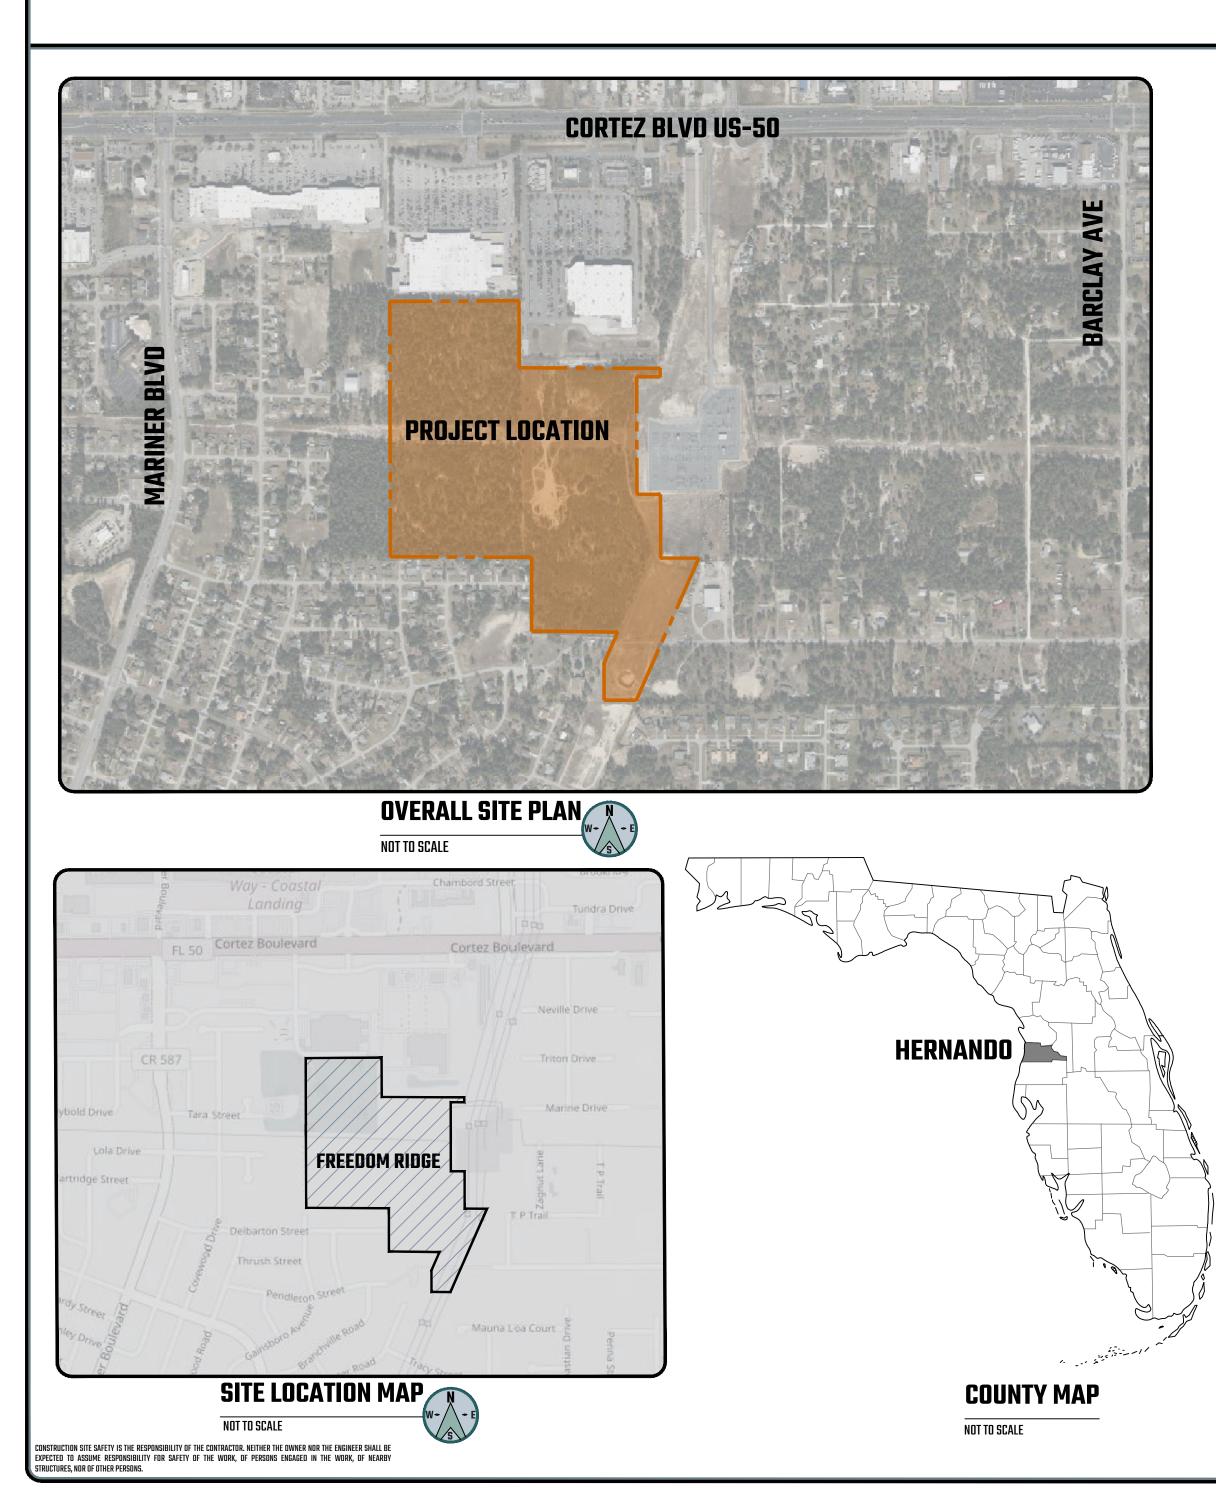

CABLE. PHONE & INTERNET CENTURY LINK COMMUNICATIONS PH: 877.348.9007

COX COMMUNICATION PH: 602.277.1000

LEGAL DESCRIPTION

The land referred to herein below is situated in the County of Hernando, State of Florida, and described as follows:

Parcel 1:

Lot 2 of DONRICH AND EVANS HI-PARK SUBDIVISION, according to the plat thereof as recorded in Plat Book 33, pages 36 and 37, of the Public Records of Hernando County, Florida.

Parcel 2

The Southeast 1⁄4 of the Southeast 1⁄4 of Section 33, Township 22 South, Range 18 East, Hernando County, Florida

Less the following described parcel

Beginning at the Southwest corner of the Southeast 1⁄4 of the Southeast 1⁄4 of said Section 33, Township 22 South, Range 18 East; run North 234.5 feet; thence East 480 feet; thence South 234.5 feet; thence West 480 feet to the point of

Also less the following described parcel

Commence at the Southwest corner of the Southeast 1⁄4 of the Southeast 1⁄4 of Section 33, Township 22 South, Range 18 East, Hernando County, Florida, said point of commencement being also the Northwest corner of Lot 16, Block 1341, SPRING HILL UNIT 20, as recorded in Plat Book 9, pages 65-80, inclusive, Public Records of Hernando County, Florida; thence North 00°07'10" West along the West line of said Southeast 1⁄4 of the Southeast 1⁄4 and along the East line of said SPRING HILL UNIT 20, a distance of 234.50 feet to the point of beginning; thence continue North 00°07'10" West, distance of 220.35 feet; thence South 89°19'28" East, a distance of 562.93 feet to the Westerly right-of-way line of the Florida Power Corporation easement as it now exists; thence South 23°44'27" West along said Westerly right-of-way line, a distance of 203.41 feet: thence South 00°07'10" East, a distance of 10.91 feet: thence North 89°38'13" West, a distance of 480.00 to the point of beginning

Also less the following described parcel

That portion of the Southeast 1⁄4 of the Southeast 1⁄4 of Section 33, Township 22 South, Range 18 East, Hernando County, Florida, lying Easterly of the Florida Power Corporation easement being described in Official Records Book 110, page 244, of the Public Records of Hernando County, Florida.

LEGAL DESCRIPTION. (PARAGON ACQUISITIONS)

The land referred to herein below is situated in the County of HERNANDO, State of Florida, and described as follows:

Commence at the NE corner of the West 1/2 of Lot 15 of EVANS HI PARK SUBDIVISION, as per plat thereof, recorded in Plat Book 6, Page 25, of the Public Records of Hernando County, Florida; thence run South along the East line of said West 1/2 of Lot 15 to the South line of said subdivision (being the SE corner of the West 1/2 of said Lot 15); thence run East to the SW corner of Donrich Subdivision, as recorded in Plat Book 12, Page 82, of the Public Records of Hernando County, Florida; thence run North along the West line of said Donrich Subdivision to the South right of way of State Road 50 (being the NW corner of said Donrich Subdivision and West of the Point of Beginning); thence run West along the South right of way of State Road 50 to the Point of Beginning. SUBJECT TO Interpretation by the United States Department of the Interior ruling recorded in Deed Book 114, Page 367, of the Public Records of Hernando County. Florida.

LESS the North 1100 feet thereof as described in Warranty Deed recorded in Official Records Book 1048, Page 1159, of the Public Records of Hernando County, Florida.

TOGETHER WITH all of Grantor's rights in the Easement over a portion of vacated Lot 15 of said EVANS HI PARK SUBDIVISION, as described in Easement found in Deed recorded in Official Records Book 1048, Page 1159, and Easements recorded in Book 1048, Page 1166 and Book 1048, Page 1169, of the Public Records of Hernando County, Florida.

ALL being a part of Lots 10, 11, 12, 13, 14 and the East 1/2 of Lot 15, EVANS HI PARK SUBDIVISION, as per map or plat thereof, as recorded in Plat Book 6, Page 25, AND as vacated in Official Records Book 1047, Page 363, as corrected by instrument recorded in Official Records Book 1050, Page 1238, of the Public Records of Hernando County, Florida.

PROJECT DESCRIPTION

PROJECT INCLUDES DEVELOPMENT OF A 246 LOT RESIDENTIAL SUBDIVISION, ROADS AND SUPPORTING UNDERGROUND INFRASTRUCTURE.

FLOODPLAIN NOTE

The subject property lies in Flood Zone "X", according to Flood Insurance Rate Map, Map No. 12053C0169D for Hernando County, Community No. 120110, Hernando County, Florida, dated February 2, 2012 and issued by the Federal Emergency Management Agency. Lines shown have been digitally translated from DFIRM database information supplied by the FEMA Map Service Center https://msc.fema.gov).



ENGINEER

UTILITY CONTACTS

POWER SALT RIVER PROJECT (SRP) PH: 602.236.8811

WATER & SEWER **CITY OF PHOENIX** PH: 602.261.8000

> Y WARNING LOCATIONS AND ELEVATIONS DE EXISTING UNDERGROUND UTILITIES AS 9 IMPLIED AS TO THE COMPLETENESS OR ACCURACY THEREOF. THE CONTRACTO LL BE EXCLUSIVELY RESPONSIBLE FOR DETERMINING THE EXACT UTILITY VATIONS PRIOR TO THE START OF CONSTRUCTION

LIST OF DRAWINGS

HEET No.
T-100
G-100
V-100
V-101
C-100
C-200
C-201
C-202
C-300
R-100

SHEET TITLE COVER SHEET GENERAL PROJECT NOTES EXISTING SITE CONDITIONS PLAN **BORING LOG OVERALL AERIAL SITE MAP** CONDITIONAL PLAT CONDITIONAL PLAT – NORTH **CONDITIONAL - SOUTH** TYPICAL SECTIONS CONDITIONS OF APPROVAL

GAS

SOUTHWEST GAS

PH: 602.271.4277

ROAD CLOSURES

PH: 602.262.6441

CLIENT

PARAGON PROPERTY GROUP 1703 N. MCMULLEN BOOTH ROAD SAFETY HARBOR, FLORIDA, 34695

CONTACT: JARED MOON PH: (727) 239-5180 EMAIL: jmoon@paragon-pg.com

PRIORITY ENGINEERING, LLC 23208 EMERSON WAY LAND O LAKES, FLORIDA 34639

CONTACT: KIRT ANDERSEN, PE

www.priority-eng.com

PROJECT NO. 22-0008

F **CITY OF PHOENIX STREETS DEPARTMENT** PRIORITY ENGINEERING, LLC Engineer's Seal TATE OF Know what's **below**. Call before you dig. Certification (1) This item has been electronically signed and sealed by Kirt M. Andersen, PE, using a Digit (?) Printed conies of this document are not considered signed and sealed and the signature verified on any electronic copies. Kirt M. Andersen. State of Florida. Professional Engineer. License No. 80097. This item has been electronically signed and sealed by Kirt M. Andersen, PE, as dated on a Digit Printed copies of this document are not considered signed and sealed and signature must be v on any electronic cop SCALE North Proiect FREEDOM RIDGE SUBDIVISION **Project Location SPRING HILL, HERNANDO COUNTY, FLORIDA 34613** Sheet Name **COVER SHEET ISSUED FOR** CONDITIONAL PLAT **APPROVAL** Revisions ISSUED FOR cond plat comments hernando county 2 COND PLAT ADD COMMENTS HERNANDO COUNTY 6/5/2024 Date: 06/24/2022 Reviewed By: BF RH ENG/CADD: **Checked By:** КМА PE Project No. 22-0008 Sheet No. T-100

IRAWING NOTE: SCALE SHOWN IS MEANT FOR 22" X 34" AND WILL SCALE INCORRE On any other size media besides 11" X 17" No reproduction shall be made without prior consent of priority engi 02 2022

GENERAL NOTES

- REGULATIONS ALL CONSTRUCTION SHALL BE DONE IN A WORKMAN LIKE MANNER AND SHALL CONFORM TO ALL COUNTY, STATE AND FEDERAL REGULATIONS AND OR CODES INCLUDING BUT NOT LIMITED TO THE CURRENT HERNANDO COUNTY AND FLORIDA DEPARTMENT OF TRANSPORTATION (FOOT) LATEST REGULATIONS. THE CONTRACTOR SHALL BE RESPONSIBLE FOR OBTAINING ALL PERMITS AND LICENSES TO BEGIN WORK AND PAY ALL REOUIRED FEES ASSOCIATED WITH SAME.
- STANDARD DETAILS AND SPECIFICATIONS STATE, COUNTY AND CITY CONSTRUCTION DETAILS AND SPECIFICATIONS SHALL BE APPLIED TO THE APPROPRIATE AREAS OF THE PLANS. GENERALLY DIFFERENTIATED BY PROPERTY OWNERSHIP LINES OR INTENT OF THE DESIGN. ANY CONFLICTS BETWEEN GOVERNING STANDARDS SHALL BE BROUGHT TO THE ATTENTION OF THE ENGINEER.
- DATUM UNLESS OTHERWISE NOTED, ELEVATIONS SHOWN HEREON REFER TO NORTH AMERICAN VERTICAL DATUM OF 1988 (NAVD 88). HORIZONTAL DATA SHOWN HEREON REFERS TO N.A.D. 83 FLORIDA STATE PLANE WEST ZONE. ANY DISCREPANCY SHALL BE BROUGHT TO THE ATTENTION OF THE ENGINEER BEFORE CONSTRUCTION BEGINS OR RESUMES.
- 4. CHANGES ALL CHANGES SHALL BE SUBMITTED IN WRITING AND APPROVED BY THE ENGINEER PRIOR TO CONSTRUCTION.
- GUARANTEE THE CONTRACTOR SHALL GUARANTEE ALL WORK AND MATERIAL FOR A PERIOD OF ONE YEAR FROM THE DATE OF PROJECT ACCEPTANCE, DURING WHICH ALL FAULTY CONSTRUCTION AND/OR MATERIAL SHALL BE REPLACED AT THE CONTRACTORS EXPENSE.
- SHOP DRAWINGS PRIOR TO CONSTRUCTION, THE CONTRACTOR SHALL SUBMIT SHOP DRAWINGS TO THE ENGINEER FOR REVIEW AND PBCWUD APPROVAL. STRUCTURE SHOP DRAWINGS SHALL BE SIGNED AND SEALED BY A PROFESSIONAL STRUCTURAL ENGINEER REGISTERED IN THE STATE OF FLORIDA.
- MAINTENANCE OF TRAFFIC (M.D.T.) UNLESS OTHERWISE PERMITTED, THE CONTRACTOR SHALL MAINTAIN EXISTING PEDESTRIAN AND VEHICULAR TRAFFIC AND ACCESS AT ALL TIMES DURING CONSTRUCTION AND SHALL PROVIDE THE NECESSARY TEMPORARY PAVEMENT. BARRICADES, LIGHTING, SIGNS, FLAGMEN, ETC, FOR THE SAFETY OF THE PUBLIC. THE CONTRACTOR SHALL SUBMIT M.O.T. AND A.D.A. ACCESS PLANS TO THE ENGINEER FOR REVIEW AND CITY, COUNTY AND STATE APPROVAL OF WORK TO BE DONE WITHIN THEIR RIGHTS OF WAY. M.O.T. SHALL BE IN ACCORDANCE WITH A.D.A., M.U.T.C.D. AND F.D.O.T. INDEX SERIES 600.
- RECORD DRAWINGS THE CONTRACTOR SHALL SUBMIT RECORD DRAWINGS TO THE ENGINEER FOR REVIEW AND APPROVAL. RECORD DRAWINGS MUST BE SIGNED AND SEALED BY A PROFESSIONAL SURVEYOR REGISTERED IN THE STATE OF FLORIDA AND BE REFERENCED TO THE DATUM SHOWN IN THE CONSTRUCTION PLANS. ANY UNMARKED UTILITIES ENCOUNTERED DURING CONSTRUCTION SHALL BE INCORPORATED INTO THE RECORD DRAWINGS. ALL UTILITIES MUST BE SHOWN IN THEIR AS-BUILT I OCATION.
- RESPONSIBILITY THE CONTRACTOR SHALL BE RESPONSIBLE FOR ALL EXISTING UTILITIES WHETHER SHOWN ON THE PLANS OR NOT. THE CONTRACTOR SHALL VERIFY THE LOCATION. SIZE AND MATERIAL OF ALL UTILITIES PRIOR TO THE COMMENCEMENT OF CONSTRUCTION. ANY DISCREPANCIES SHALL BE BROUGHT TO THE ATTENTION OF THE ENGINEER. THE APPROPRIATE UTILITY COMPANY SHALL BE NOTIFIED PRIOR TO ANY CONSTRUCTION IN OR AROUND THAT UTILITY. CALL "SUNSHINE STATE ONE CALL" AT 1-800-432-4770 PRIOR TO ANY EXCAVATION. THE ENGINEER AND OWNER SHALL BE HELD HARMLESS AGAINST ALL CLAIMS OR DAMAGES.
- 10. RESTORATION THE CONTRACTOR SHALL IMMEDIATELY REPAIR AND RESTORE EXISTING SITE FEATURES INCLUDING PAVEMENT, DRIVEWAYS, PIPES, FENCES, TRAFFIC CONTROL DEVICES, MAILBOXES AND PROPERTY CORNERS DAMAGED AS A RESULT OF CONSTRUCTION ACTIVITIES. THE REPAIR AND RESTORATION SHALL CONFIRM TO APPLICABLE STANDARDS AS GOVERNED.
- OPEN TRENCHES ALL OPEN TRENCHES AND HOLES SHALL BE PROPERLY MARKED AND BARRICADED TO INSURE THE SAFETY OF VEHICULAR AND PEDESTRIAN TRAFFIC. NO OPEN TRENCHES OR HOLES SHALL BE LEFT OPEN DURING NIGHT TIME HOURS WITHOUT EXPRESSED PERMISSION FROM THE OWNER, ENGINEER AND REGULATING AGENCIES. ALL TRENCHES SHALL COMPLY WITH OSHA TRENCH SAFETY ACT PROVISIONS.
- 2. CONFLICTS ANY CONFLICTING INFORMATION BETWEEN REGULATING AGENCIES AND THE CONSTRUCTION DOCUMENTS SHALL BE IMMEDIATELY BROUGHT TO THE ATTENTION OF THE ENGINEER AFFECTED CONSTRUCTION SHALL NOT COMMENCE OR RESUME UNTIL PERMISSION IS GRANTED BY THE ENGINEER OR OWNER

CLEARING AND GRUBBING

- CLEARING CLEARING SHALL BE LIMITED TO THE CONSTRUCTION AREA AND/OR AS DIRECTED BY THE ENGINEER OR OWNER AND APPROVED BY THE COUNTY.
- GRUBBING ALL STUMPS, ROOTS, BURIED LOGS OR OTHER UNSUITABLE MATERIAL WITHIN THE LIMITS OF PAVEMENT CONSTRUCTION SHALL BE REMOVED TO A DEPTH OF 3 FEET BELOW FINISHED PAVEMENT ELEVATION AND REPLACED WITH CLEAN FILL
- DEBRIS REMOVAL ALL DEBRIS SHALL BE REMOVED FROM THE SITE AND LEGALLY DISPOSED. ANY MATERIAL RETAINED ON-SITE FOR MORE THAN 30 DAYS SHALL BE STORED IN CONTAINERS APPROVED BY THE ENGINEER AND COUNTY.
- PROTECTION THE CONTRACTOR SHALL BE RESPONSIBLE TO PROTECT ALL EXISTING BUILDINGS, UTILITIES, STRUCTURES THAT ARE ABOVE OR BELOW GROUND AND SHALL HOLD THE ENGINEER AND OWNER HARMLESS AGAINST ALL CLAIMS OR DAMAGES.
- LANDSCAPED AREAS ALL LANDSCAPE PLANTING AREAS SHALL BE FREE OF BASE ROCK AND CONSTRUCTION DEBRIS AND EXCAVATED TO A MINIMUM DEPTH OF 30" OR TO CLEAN, NATIVE SOIL. REFER TO THE LANDSCAPE PLANS (BY OTHERS) FOR ADDITIONAL PLANTING INFORMATION AND DETAILS.
- 6. MUCK ANY MUCK ENCOUNTERED WITHIN 10' OF THE PAVEMENT AND BUILDING AREAS SHALL BE REMOVED AND REPLACED WITH CLEAN FILL MATERIAL.
- HARDPAN HARDPAN ENCOUNTERED IN THE DETENTION AREA SHALL BE REMOVED AND REPLACED WITH CLEAN, GRANULAR FILL MATERIAL.

URBAN FORESTRY PERMIT NOTES 2021

- IT IS THE RESPONSIBILITY OF THE CONTRACTOR TO PROTECT ALL TREES WITHIN THE VICINITY OF THE PROPOSED CONSTRUCTION IN ACCORDANCE WITH CHAPTER 27 OF THE HERNANDO COUNTY CODE. TREE REMOVAL IS NOT AUTHORIZED WITHOUT PRIOR APPROVAL FROM THE HERNANDO COUNTY PARKS AND RECREATION URBAN FORESTRY
- PRUNING OF BRANCHES IS NOT AUTHORIZED WITHOUT PRIOR APPROVAL FROM THE HERNANDO COUNTY PARKS AND RECREATION URBAN FORESTRY MANAGER AND SHALL BE COMPLETED BY/UNDER THE SUPERVISION OF AN INTERNATIONAL SOCIETY OF ARBORICULTURE CERTIFIED ARBORIST. PRUNING OF CHAPTER 27 DESIGNATED GRAND TREES WILL **REQUIRE AN ADDITIONAL GRAND TREE PRUNING**
- EXCAVATION WITHIN THE PROTECTIVE RADIUS OF TREES IS NOT AUTHORIZED WITHOUT PRIOR APPROVAL FROM THE HERNANDO COUNTY PARKS AND RECREATION URBAN • 10 FEET RADIUS FOR PROTECTED TREES (CHAPTER 27 - TREES GREATER THAN 5 INCHES IN DIAMETER AT 4.5 FEET) • 15 FEET RADIUS FOR SPECIMEN TREES (CHAPTER 27 - TREES GREATER THAN 24 INCHES IN DIAMETER AT 4.5 FEET) • 20 FEET RADIUS FOR GRAND TREES (CHAPTER 27 – TREES GREATER THAN 32 INCHES IN DIAMETER AT 4.5 FEET)
- ROOTS 2" OR GREATER SHALL NOT BE PRUNED WITHOUT PRIOR APPROVAL FROM THE HERNANDO COUNTY PARKS AND RECREATION URBAN FORESTRY MANAGER.
- FOR QUESTIONS REGARDING THESE REQUIREMENTS, PLEASE CONTACT THE HERNANDO COUNTY PARKS AND RECREATION URBAN FORESTRY MANAGER AT 813-274-5137 OF 813-557-0482, STAFE IS AVAILABLE TO MEET WITH THE CONTRACTOR TO GO OVER THESE COMMENTS.

FIELD OBSERVATIONS AND TESTING

- NOTIFICATION THE CONTRACTOR SHALL NOTIFY THE ENGINEER, GOVERNMENT AND OTHER PERMITTING AGENCIES 48 HOURS PRIOR TO SCHEDULING FIELD OBSERVATIONS AND SHALL SUPPLY ALL EQUIPMENT NECESSARY TO TEST THE COMPLETED WORK. CALL "SUNSHINE ONE CALL" AT 1-800-432-4770 PRIOR TO ANY EXCAVATION.
- THE UNDERGROUND CONTRACTOR SHALL SUBMIT ALL RECORD DATA, SIGNED AND SEALED BY A PROFESSIONAL SURVEYOR AND MAPPER REGISTERED IN THE STATE OF FLORIDA, TO THE ENGINEER FOR REVIEW AND APPROVAL PRIOR TO CURB AND PAVEMENT CONSTRUCTION. ANY NECESSARY ADJUSTMENTS AT THIS TIME SHALL BE THE RESPONSIBILITY OF THE CONTRACTOR
- DRAINAGE PIPES AND STRUCTURES SHALL BE INSPECTED BY THE ENGINEER AND COUNTY PRIOR TO BACKEILLING. ALL DRAINAGE SYSTEMS SHALL BE PIIMPED DOWN TO BELOW THE INVERT AND LAMPED AS A REQUIREMENT OF THE FINAL DRAINAGE INSPECTION.
- ALL TESTS SHALL BE SIGNED AND SEALED BY A PROFESSIONAL ENGINEER REGISTERED IN THE STATE OF FLORIDA AND ARE TO BE PAID FOR BY THE CONTRACTOR.
- 5. THE BASE ROCK CHEMICAL AND SIEVE ANALYSIS AND THE ASPHALT MIX AND DESIGN CRITERIA SHALL BE SUBMITTED TO THE ENGINEER FOR REVIEW PRIOR TO CONSTRUCTION
- PROCTOR AND DENSITY TESTS FOR SUBGRADE AND BASE MATERIAL SHALL BE TAKEN AS DIRECTED BY THE ENGINEER. PAVING DENSITY TESTS SHALL BE TAKEN A MINIMUM OF ONE PER 500 S.Y.
- DENSITY TEST FOR PIPE TRENCHES SHALL BE TAKEN AT THE PIPE SPRING-LINE AND AT MAXIMUM ONE FOOT (1') LIFTS AS MEASURED FROM THE TOP OF PIPE. THE TESTS SHALL BE TAKEN AT A MAXIMUM SPACING OF EVERY 300 FEET MEASURED FROM THE STRUCTURE OR AT LEAST ONE TEST AT THE CENTER OF THE PIPE SEGMENT BETWEEN TWO STRUCTURES IF LESS THEN 300 FEET. TESTS SHALL BE TAKEN ON ALL SIDES WITHIN FIVE (5') OF EACH STRUCTURE. THE TEST LOCATION AT THE STRUCTURE SHALL BE ON ALTERNATING SIDES OF THE STRUCTURE WITH EACH LIFT TESTED. THE LOCATION AND DEPTH OF ALL TESTS SHALL BE CLEARLY INDICATED IN THE DESCRIPTION AREA ON THE TEST REPORT OR ILLUSTRATED IN A MAP.
- TESTING TEST RESULTS SHALL BE SUBMITTED TO THE ENGINEER FOR REVIEW AND APPROVAL. TESTING REQUIREMENTS SHALL INCLUDE, BUT MAY NOT BE LIMITED TO, BACKFILL DENSITY, PIPELINE INTEGRITY (HYDROSTATIC PRESSURE) AND ANY OTHERS REQUIRED BY THE ENGINEER, PBCWUD OR PERMITTING AGENCIES.

MAINTENANCE OF TRAFFIC

- CONTRACTOR SHALL BE RESPONSIBLE FOR PROVIDING ALL MAINTENANCE OF TRAFFIC, INCLUDING SIGNAGE AND BARRICADES AS NEEDED IN ACCORDANCE WITH APPI ICABLE PERMITS AND HERNANDO COUNTY PUBLIC WORKS DEPARTMENT
- MOT WITHIN FDOT RIGHT OF WAY AND SURROUNDING COUNTY STREETS SHALL CONFORM TO THE FDOT STANDARD INDEX 102 SERIES AS APPROPRIATE.
- CONTRACTOR SHALL PROVIDE 24 HOURS NOTICE TO LOCAL EMERGENCY SERVICES DEPARTMENT(S) WHENEVER CONSTRUCTION ACTIVITIES ARE EXPECTED TO IMPEDE NORMAL TRAFFIC FLOW.
- THE CONTRACTOR SHALL SUBMIT MAINTENANCE OF TRAFFIC PLANS TO APPROPRIATE REGULATORY AGENCIES HAVING JURISDICTION OVER IMPACTED ROADWAYS. CONSTRUCTION SHALL NOT COMMENCE WITHIN ROW UNTIL MOT APPROVALS FOR IMPACTED ROAD ARE RECEIVED.

PAVING AND DRAINAGE

- 1. SUBGRADE SUBGRADE SHALL BE COMPACTED TO 98% MAXIMUM DENSITY IN ACCORDANCE WITH AASHTO T-180 (ASTM-1557) SPECIFICATIONS. ALL STUMPS, ROOTS, AND OTHER DELETERIOUS MATERIAL ENCOUNTERED SHALL BE REMOVED TO A DEPTH OF 3 FEET BELOW FINISHED ROAD GRADE AND REPLACED WITH CLEAN FILL COMPACTED TO NOT LESS THAN 100% OF MAXIMUM DENSITY. ALL SUCH MATERIAL SHALL BE REMOVED FROM WITHIN 8 FEET OF THE EDGE OF PAVEMENT. STABILIZED SUBGRADE SHALL CONFORM TO SECTION 160 OF FDOT SPECIFICATIONS FOR ROAD AND BRIDGE CONSTRUCTION AND HAVE A MINIMUM LBR OF 40.
- 2 BASE APPROVED SHELLROCK AND LIMEROCK SHALL CONFORM TO APPLICABLE SECTIONS OF THE LATEST FOOT SPECIFICATIONS BASE COURSE SHALL BE COMPACTED TO 98% OF THE MAXIMUM DENSITY AS DETERMINED BY AASHTO T-180 (ASTM 1557). PRIME COAT MINIMUM APPLICATION RATE OF 0.10 GAL/S.Y. TACK COAT MINIMUM APPLICATION RATE OF 0.05 GAL/SY.
- 3. ASPHALT CONCRETE STRUCTURAL AND SURFACE COURSES SHALL CONFORM TO APPLICABLE SECTIONS OF THE CURRENT FDOT SPECIFICATIONS.
- 4. STRUCTURES INLETS AND MANHOLES SHALL BE AS SPECIFIED ON THE PLANS AND SHALL BE CONSTRUCTED IN ACCORDANCE WITH APPLICABLE SECTIONS OF THE CURRENT FDOT SPECIFICATIONS. INLET GRATES SHALL BE SECURED IN ACCORDANCE WITH FDOT INDEX NO 201.
- PIPES DRAINAGE PIPES SHALL CONFORM WITH THE APPLICABLE SECTIONS OF THE CURRENT FDOT SPECIFICATIONS.
- 6. REINFORCING STEEL ALL REINFORCING STEEL SHALL CONFORM TO ASTM A- 615 SPECIFICATIONS.
- 7. CONCRETE CONCRETE SHALL DEVELOP A 28-DAY MINIMUM COMPRESSIVE STRENGTH OF 4000 PSI UNLESS OTHERWISE NOTED ON THE PLANS AND SHALL CONFORM TO THE APPLICABLE SECTIONS OF THE CURRENT FOOT SPECIFICATIONS.
- 8. PIPE BACKFILL PIPE BACKFILL SHALL CONFORM TO THE APPLICABLE SECTIONS OF THE CURRENT FDOT SPECIFICATIONS. PIPE BACKFILL SHALL BE PLACED IN 6" LIFTS AND COMPACTED TO NOT LESS THAN 100% MAXIMUM DENSITY AS DEFINED BY AASHTO T-180.
- 9. TRAFFIC CONTROL DEVICES ALL TRAFFIC CONTROL DEVICES, PAVEMENT MARKINGS AND SIGNS SHALL BE AS DEFINED IN THE MANUAL ON UNIFORM TRAFFIC CONTROL DEVICES FOR STREETS AND HIGHWAYS (MUTCD), HERNANDO COUNTY TYPICAL #T-P-18 AND/OR THE CURRENT FDOT SPECIFICATIONS, WHERE APPLICABLE. THERMOPLASTIC MATERIAL SHALL BE USED FOR FINAL PAVEMENT MARKINGS EXCEPT PARKING SPACES. IF PAVER BRICKS ARE USED IN MARKED PAVEMENT, BRICKS OF APPROPRIATE COLOR AND CONTRAST SHALL BE USED IN LIEU OF PAINT OR THERMOPLASTIC MATERIAL PAINT MAY BE USED FOR TEMPORARY STRIPING.
- 10. WHERE CONNECTIONS TO AN EXISTING DRAINAGE SYSTEM ARE PROPOSED, SAID EXISTING DRAINAGE STRUCTURES AND LINES SHALL BE CLEANED OF ALL SILT AND OTHER DEBRIS PRIOR TO SAID CONNECTIONS BEING MADE, AND WHERE THE EXISTING DRAINAGE SYSTEM INCLUDES DITCHES, SAID DITCHES SHALL BE CLEARED AND REWORKED, AS NECESSARY, TO RESTORE THEM TO AN APPROVED DESIGN SECTION. DRAINAGE SYSTEMS ARE TO BE CLEANED AND/OR GRADED TO THE POINT OF LEGAL POSITIVE OUTFALL
- 11. ALL HANDICAP ACCESSIBLE RAMPS SHALL MEET ALL APPLICABLE LOCAL, STATE, AND FEDERAL ACCESSIBILITY GUIDELINES AND REGULATIONS. ANY MODIFICATIONS SHALL BE APPROVED BY THE ENGINEER OF RECORD. HANDICAP PARKING SIGNS SHALL BE PLACED A) BEHIND THE SIDEWALK OR B) ATTACHED TO BUILDING WALLS IN AREAS WHERE A SIDEWALK AND/OR BUILDING ABUTS THE STALL OR C) OUTSIDE THE TWO (2') FEET OVERHANG AREA WHERE WHEEL STOPS ARE NOT PROVIDED.
- 12. CONTRACTOR SHALL CONTACT HERNANDO COUNTY TRAFFIC OPERATIONS AT 561-233-3900 FORTY-EIGHT (48) HOURS PRIOR TO CONSTRUCTION IF WORK IS BEING DONE WITHIN 10 FEET OF ANY
- 13. DAMAGES TO LOOPS OR ANY SIGNAL EQUIPMENT CAUSED BY CONSTRUCTION OF THIS PROJECT MUST BE REPAIRED OR REPLACED TO ORIGINAL OR BETTER CONDITION AT NO COST TO HERNANDO COUNTY.
- 14. MINIMUM PERIMETER BERM ELEVATION SHALL BE EQUAL OR GREATER TO THE 25YEAR-3DAY PEAK STAGE ELEVATION 15.55 (NAVD88)

ENVIRONMENTAL PROTECTION NOTES

SIGNAL EQUIPMENT

WITHIN THAT AREA.

- CONSTRUCTION EQUIPMENT SHALL NOT BE OPERATED IN WETLAND AREAS UNLESS SUCH CONSTRUCTION PRACTICES ARE APPROVED IN A PLAN OF OPERATION SUBMITTED TO THE ENGINEER & THE APPROPRIATE REGULATORY AUTHORITIES. WHERE CONSTRUCTION IS NECESSARY ACROSS OR ADJACENT TO WETLAND JURISDICTIONAL AREAS, SILT BARRIERS SHALL BE INSTALLED AS SHOWN ON THE PLANS. SILT BARRIERS SHALL BE CONSIDERED LIMITS OF CONSTRUCTION WITHIN OR ADJACENT TO JURISDICTIONAL AREAS. CONSTRUCTION SHALL PROCEED SUCH THAT ALL STORMWATER FACILITIES WITHIN A WATERSHED AREA ARE IN PLACE AND OPERATIONAL PRIOR TO CONSTRUCTION OF IMPERVIOUS SURFACES
- STAKED OR FLOATING SILT SCREENS OR SYNTHETIC HAY BALES, AS APPROPRIATE. SHALL BE UTILIZED AS SILT BARRIERS AND PLACED IN LOCATIONS SHOWN ON THE PLANS AND AT OTHER LOCATIONS AS REQUIRED TO KEEP SEDIMENT FROM REACHING WATER BODIES OR WETLAND AREAS. ONCE CONSTRUCTION IS COMPLETE AND FINISH GRADING / STABILIZATION HAS BEEN ACHIEVED. SILT BARRIERS SHALL BE COMPLETELY REMOVED TO THE SATISFACTION OF THE OWNER AND PRIOR TO FINAL ACCEPTANCE.
- ALL FUGITIVE DUST SHALL BE CONTROLLED ON SITE. ONLY AREAS SCHEDULED FOR IMMEDIATE CONSTRUCTION SHALL BE CLEARED OR STRIPPED OF VEGETATION. WATERING OR OTHER PRIOR APPRIVED MEANS OF DUST CONTROL SHALL BE FMPLOYED TO PREVENT THE FMANATION OF DUST FROM THE SITE. PERMANENT GRASSING, LANDSCAPING AND OTHER SITE WORK SHALL BE INITIATED AS SOON AS POSSIBI F
- ALL WATER COLLECTED AND PUMPED DURING TRENCH DEWATERING ACTIVITIES SHALL BE DISPOSED OF IN UPLAND AREAS INTO DOUBLE STAKED HAY BALES. DISCHARGE LOCATIONS SHALL BE A MINIMUM OF 75 FEET FROM THE NEAREST SURFACE WATER BODY OR WETLAND AREA. TO ALLOW FOR MAXIMUM OVERLAND FILTRATION OF SOIL PARTICLES.
- TEMPORARY STOCKPILES SHALL NOT BE LOCATED ADJACENT TO UNDISTURBED WETLANDS. ADDITIONALLY, STOCKPILES TO REMAIN FOR LONGER THAN 24 HOURS SHALL BE CONFINED BY SILT BARRIERS WHICH PREVENT RUNDFF SEDIMENTATION FROM ENCROACHING UPON WETLAND AREAS OR SURFACE WATER STOCKPILES IN PLACE AND UNTOUCHED FOR 7 DAYS OR MORE TO HAVE VEGETATIVE COVER TO PREVENT WIND EROSION AND SEDIMENT DISPERSAL.
- ALL TRASH AND CONSTRUCTION DERRIS PRODUCED FROM THIS DROLIECT SHALL BE COLLECTED BY THE CONTRACTOR DALLY. THESE MATERIALS SHALL BE STAGED OR CONTAINERIZED AS NECESSARY TO PREVENT ACCIDENTAL RELEASE. DISPOSAL OF SOLID WASTE MATERIALS SHALL BE IN ACCORDANCE WITH APPLICABLE MINICIPAL COUNTY AND STATE REGULATIONS.
- THE CONTRACTOR SHALL MAINTAIN CONTROL OF ANY HAZARDOUS MATERIALS UTILIZED ON-SITE FOR CONSTRUCTION. STORAGE CONTAINERS, VEHICLES, ETC. WILL BE INSPECTED REGULARIY FOR LEAKAGE. A SPILL PREVENTION PLAN SHALL BE ESTABLISHED WHICH COVERS CLEANUP AND NOTIFICATION OF APPROPRIATE GOVERNMENT AGENCIES.
- CONTRACTOR SHALL NOT REMOVE TREES WITHOUT APPROVAL OF THE LOCAL GOVERNING JURISDICTION. TREE PROTECTION SHALL BE IN ACCORDANCE WITH LOCAL GOVERNING AUTHORITY.
- THE CONTRACTOR IS RESPONSIBLE FOR CONTROLLING SITE FROSION AND SHALL NOT LINNECESSARILY REMOVE EXISTING VEGETATION OR ALTER EXISTING TOPOGRAPHY. THE CONTRACTOR SHALL PROVIDE ADDITIONAL SOD. SYNTHETIC HAY BALES. SAND BAGS OR SEED & MULCH. AS NECESSARY. TO ACHIEVE AN EROSION-FREE SITE IFREE FROM RUTTING. ETC.) TO THE LINES AND GRADE SHOWN IN THE PLANS UNTIL FINAL ACCEPTANCE. ALL SWALES AND SURFACES 4:1 OR STEEPER SHALL BE SODDED. ALL OTHER UNPAVED SURFACES WHICH EXPERIENCE UNDUE EROSION THAT CANNOT BE CONTROLLED BY OTHER MEASURES SHALL BE SODDED. ALL SOD SHALL BE ARGENTINE BAHIA UNLESS SPECIFICALLY SHOWN OTHERWISE IN THE CONTRACT DOCUMENTS. ALL SODDED SLOPES OVER 4:1. SHALL BE INSTALLED WITH SOD PEGS.
- SOIL EROSION AND SEDIMENT CONTROL DEVICES SHALL BE INSTALLED PRIOR TO CONSTRUCTION, MAINTAINED THROUGHOUT CONSTRUCTION AND UNTIL THE SITE IS PERMANENTLY STABILIZED. SEE SWPP CSWMP NOTES AND DETAIL SHEETS FOR ADDITIONAL INFORMATION
- THE CONTRACTOR SHALL BE RESPONSIBLE FOR REMOVAL OF TEMPORARY SEDIMENT/EROSION CONTROL DEVICES WHEN NO LONGER NEEDED

TECHNICAL SPECIFICATIONS

- ALL SITE AND UTILITY WORK PERFORMED ON THIS PROJECT SHALL BE GOVERNED BY THE APPLICABLE PROVISIONS OF THE HERNANDO COUNTY. IN ADDITION. THE FOLLOWING STANDARDS ARE INCORPORATED BY REFERENCE:
- STANDARD FOR DESIGN AND CONSTRUCTION OF WATER. WASTEWATER. AND RECLAIMED WATER FACILITIES FOR HERNANDO COUNTY, LATEST EDITION.
- FLORIDA DEPARTMENT OF TRANSPORTATION "ROADWAY AND TRAFFIC DESIGN STANDARDS", LATEST EDITION.
- FLORIDA DEPT. OF TRANSPORTATION "STANDARD SPECIFICATIONS FOR ROAD AND BRIDGE CONSTRUCTION". LATEST EDITION. MANUAL ON UNIFORM TRAFFIC CONTROL DEVICES (MUTCD), LATEST EDITION.
- HERNANDO COUNTY DEPARTMENT OF PUBLIC WORKS / ENGINEERING FACILITY DESIGN GUIDELINES. LATEST EDITION.
- FLORIDA DEPARTMENT OF TRANSPORTATION "UTILITY ACCOMMODATION MANUAL", LATEST EDITION.

THE CONTRACTOR IS RESPONSIBLE FOR PROVIDING AND MAINTAINING PORTABLE SANITARY WASTE UNITS ON-SITE FOR USE BY HIS EMPLOYEES DURING CONSTRUCTION.

HERNANDO COUNTY NOTES

- A RIGHT OF WAY USE PERMIT IS REQUIRED FOR ANY WORK IN COUNTY RIGHT OF WAY. APPROVED CONSTRUCTION PLANS AND MOT (MAINTENANCE OF TRAFFIC) PLAN ARE REQUIRED TO APPLY FOR PERMIT.
- CONTRACTOR TO SCHEDULE A PRE-CONSTRUCTION MEETING FIVE (5) BUSINESS DAYS PRIOR TO THE START OF CONSTRUCTION. CONTRACTOR MUST PROVIDE ALL RIGHT OF WAY SUBMITTALS TO DPW INSPECTOR FOR REVIEW AND APPROVAL A MINIMUM OF THREE (3) BUSINESS DAYS PRIOR TO PRE-CONSTRUCTION MEETING. DPW INSPECTOR MUST ATTEND THE PRF-CONSTRUCTION MEETING
- CONTRACTOR TO NOTIFY DPW INSPECTOR 48 HOURS PRIOR TO CONSTRUCTION IN THE COUNTY RIGHT OF WAY. DPW INSPECTOR MUST BE PRESENT FOR ALL PAVING / POURING ON COUNTY OWNED INFRASTRUCTURE. (CONTACT DPW INSPECTORS AT 352-754-4060 OR EMAIL TO DPWResourceobject@Hernandocounty.us)
- CONTRACTOR SHALL PROVIDE 24 HOUR NOTICE TO LOCAL EMERGENCY SERVICES DEPARTMENTS WHENEVER CONSTRUCTION ACTIVITIES ARE EXPECTED TO IMPEDE NORMAL TRAFFIC FLOW.

EXISTING/RECORD UTILITIES NOTES

- THE LOCATION OF THE EXISTING UTILITIES AS SHOWN WERE OBTAINED FROM MUNICIPAL AND UTILITY COMPANY RECORDS. FIELD OBSERVATIONS AND OWNER PROVIDED DRAWINGS. NO GUARANTEE CAN BE MADE REGARDING THE COMPLETENESS OR EXACTNESS OF THE UTILITIES LOCATION. IT IS THE CONTRACTORS RESPONSIBILITY TO VERIEV IN THE FIELD THE EXACT HORIZONTAL AND VERTICAL LOCATION OF ALL UTILITIES SHOWN. REFERENCED OR MARKED IN THE FIELD. CONTRACTOR TO REPORT ANY CONFLICTS IN THE FIELD TO THE ENGINEER. CONTRACTOR METHODS FOR UTILITY LOCATING SHALL AT A MINIMUM INCLUDE UTILIZING A UTILITY LOCATING COMPANY, HYDRO EXCAVATION, SOFT DIG AND POT HOLING.
- THE ENGINEER ASSUMES NO RESPONSIBILITY FOR THE ACCURACY OF THE LOCATION OF THE UNDERGROUND UTILITIES. THE CONTRACTOR SHALL BE RESPONSIBLE FOR AVOIDING ALL EXISTING UTILITIES BY CALLING FLORIDA ONE CALL SYSTEM AT 811 FOR LOCATION OF ALL UTILITIES, AT LEAST 72 HOURS PRIOR TO BEGINNING CONSTRUCTION.
- VERTICAL DATUM USED IN DRAWINGS: NORTH AMERICAN VERTICAL DATUM OF 1988 (NAVD88) HORIZONTAL DATUM USED IN DRAWINGS: NORTH AMERICAN DATUM OF 1983, FLORIDA STATE PLANES, WEST ZONE, U.S. FEET (NAD83)

GENERAL UTILITY NOTES

- ALL UTILITY CONSTRUCTION SHALL MEET OR EXCEED HERNANDO COUNTY STANDARDS FOR WATER AND WASTEWATER CONSTRUCTION.
- NO CONNECTION TO THE EXISTING UTILITY LINES SHALL BE MADE WITHOUT PRIOR APPROVAL OF THE COUNTY UTILITIES DEPARTMENT
- ALL WATER MAINS SHALL HAVE A MINIMUM OF 36" COVER, UNLESS SPECIFIED OTHERWISE. FORCE MAINS SHALL HAVE A MINIMUM OF 46" COVER.
- ALL ITH ITY LINES SHALL HAVE AN "FARLY WARNING" PROTECTION TAPE INSTALLED CONTINUINISIY ALONG THE PIPE ALIGNMENT IN ACCORDANCE WITH THE ITH ITY HAVING JURISDICTION THE PROTECTION TAPE SHALL BE INSTALLED DURING BACK FILING 18" DIRECTLY OVER THE PIPE, OR AS SPECIFIED BY UTILITY OWNER. THE TAPE SHALL HAVE A METAL DETECTABLE STRIP
- SANDWICHED BETWEEN 2 LAYERS OF POLYETHYLENE. FOR WATER LINES, THE TAPE SHALL BE CONTINUOUSLY MARKED "CAUTION, WATER LINES BELOW". FOR FORCE MAINS, THE TAPE SHALL BE
- CONTINUOUSLY MARKED "CAUTION, SEWAGE FORCE MAIN BELOW". FOR SANITARY SEWER, THE TAPE SHALL BE CONTINUOUSLY MARKED "CAUTION, SEWER MAIN BELOW". BOTH WATER MAINS AND SANITARY SEWER FORCE MAINS SHALL ALSO HAVE A "LOCATOR DETECTOR WIRE" - UL TYPE AWG #10 SOLID STRAND COPPER WIRE W/60MM PVC WALL INSTALLED ALONG THE ENTIRE LENGTH OF PIPE.
- THE CONTRACTOR IS CAUTIONED THAT THE LOCATION OF EXISTING UTILITIES, WHEN SHOWN, ARE APPROXIMATE. IT SHALL BE THE RESPONSIBILITY OF THE CONTRACTOR TO OBTAIN ACTUAL
- LOCATIONS FROM THE RESPECTIVE UTILITY COMPANY AND TO COORDINATE WITH AFFECTED UTILITY COMPANY 48 HOURS BEFORE BEGINNING ANY WORK.
 - AT & T TELEPHONE 1-800-472-4700 BRIGHTHOUSE CABLE TV 1-800-892-3499 WRFC 1-352-567-5133 HERNANDO COUNTY UTILITIES DEPT 1-352-754-4037 SUNSHINE 811 1-800-432-4770 TECO 1-813-228-1626 VERIZON 1-800-483-4000
- ALL PVC FORCE MAINS 4-12" SHALL BE AWWA C-900, DR 18 PVC WITH AWWA APPROVED DUCTILE IRON MECHANICAL JOINT FITTINGS AND SHALL BE GREEN PIPE (WHITE OR BLACK LETTERING)
- ALL PVC WATER MAINS 4-12" SHALL BE AWWA C-900, DR 18 PVC WITH AWWA APPROVED DUCTILE IRON MECHANICAL JOINT FITTINGS AND SHALL BE BLUE (WHITE OR BLACK LETTERING)
- SANITARY SEWER (GRAVITY) PIPE SHALL CONFORM TO ASTM 3034 FOR SDR26 PVC BELL AND SPIGOT GASKETED JOINTS.
- ADDITIONAL REQUIREMENTS FOR PVC, DUCTILE IRON AND HDPE PIPING ARE CONTAINED IN THE CONTRACT DOCUMENTS AND TECHNICAL SPECIFICATIONS FOR THIS PROJECT.
- ALL PVC PIPE SHALL HAVE LETTERING APPEARING ON THREE SIDES OF THE PIPE. SHALL RUN THE ENTIRE LENGTH OF THE PIPE AND SHALL BE 3/4" IN HEIGHT WITH THE APPROXIMATE WORDING APPEARING ONE OR MORE TIMES EVERY 21 INCHES ALONG THE LENGTH OF THE PIPE. THE LETTERING MUST BE
- PERMANENTLY STENCILED TO THE PIPE SURFACE, LETTERING SHALL READ AS IS ACCEPTABLE FOR THE INTENDED USE. ALL LETTERING SHALL BE APPLIED BY THE PIPE MFG. DURING
- THE CONTRACTOR SHALL PERFORM LEAK TESTING ON ALL GRAVITY SEWERS AND A PRESSURE TEST ON ALL WATER AND FORCE MAINS (AS APPLICABLE) IN ACCORDANCE WITH THE UTILITY
- JURISDICTION AND/OR AS STATED IN THE SPECIFICATIONS OR AS DIRECTED BY THE ENGINEER. TESTS ARE TO BE CERTIFIED BY THE ENGINEER OF RECORD. THE SCHEDULING, COORDINATION
- NOTIFICATION OF ALL PARTIES IS THE CONTRACTOR'S RESPONSIBILITY.
- WATER AND WASTEWATER SYSTEMS SHALL NOT BE PLACED IN SERVICE (FOR TEMPORARY OR PERMANENT UNTIL ALL TESTING AND INSPECTIONS HAVE BEEN COMPLETED, TEST REPORTS AND "AS-BUILTS" FOR THOSE SYSTEMS SUBMITTED, AND CLEARANCE HAS BEEN OBTAINED FROM THE APPLICABLE UTILITIES AND PERMITTING AGENCIES. NO WATER SYSTEM SHALL BE PLACED IN SERVICE BEFORE SEWER SYSTEM HAS BEEN CLEARED FOR LISE.
- DISINFECTION AND BACTERIOLOGICAL TESTING OF ALL WATER LINES SHALL BE PERFORMED IN ACCORDANCE WITH FDEP REGULATION 62-555.340.
- DEFLECTION TESTING FOR GRAVITY SEWER LINES SHALL BE PERFORMED IN ACCORDANCE WITH "RECOMMENDED STANDARDS FOR WASTEWATER FACILITIES (10 STATE STANDARDS)", CURRENT EDITION
- TESTING OF SUBAQUEOUS LINES SHALL COMPLY WITH FAC 62-604.400(2).
- THE CONTRACTOR SHALL COMPLY WITH LOCAL CROSS-CONNECTION CONTROL POLICY FOR CONSTRUCTION OF ALL POTABLE. SANITARY AND RECLAIMED UTILITIES.
- CONTRACTOR TO PROVIDE THRUST BLOCKING AND/OR JOINT RESTRAINTS TO FULLY RESTRAIN PRESSURE PIPES AGAINST FAILURE UP TO A TEST PRESSURE OF 150 psi. CONTRACTOR SHALL PROVIDE A RESTRAINING PLAN FOR THE ENGINEER'S REVIEW AND APPROVAL PRIOR TO CONSTRUCTION.
- WARNING SIGNS SHALL BE INSTALLED AT ANY SURFACE WATER CROSSING IN ACCORDANCE WITH FAC 62-604.400(2)(k)2
- ALL UTILITY CONSTRUCTION SHALL BE IN ACCORDANCE WITH THE DOCUMENTS REFERENCED HEREIN. ANY METHODS, PROCEDURES, STANDARDS, EQUIPMENT, OR MATERIALS WHICH ARE NOT COVERED OR SPECIFIED BY THE APPLICABLE PROVISIONS OF COUNTY SPECIFICATIONS SHALL BE CONSTRUCTED TO BE IN ACCORDANCE WITH THE F.D.O.T. STANDARD SPECIFICATIONS FOR ROAD AND BRIDGE CONSTRUCTION AND F.D.O.T. UTILITIES ACCOMMODATION GUIDE UNLESS SPECIFICALLY APPROVED BY THE ENGINEER OF IN THE CASE OF CONFLICTING SPECIFICATIONS, THE MOST STRINGENT SHALL APPLY.
- ALL ITTLITTES SHALL BE KEPT IN OPERATION EXCEPT WITH THE EXPRESS WRITTEN CONSENT OF THE UTILITY OWNER. IT SHALL BE THE CONTRACTOR'S RESPONSIBILITY TO PRESERVE EXISTING UTILITIES. ANY AND ALL DAMAGE TO EXISTING UTILITIES AS A RESULT OF THE CONTRACTOR'S ACTIONS SHALL BE REPAIRED AT THE CONTRACTOR'S EXPENSE.
- WHERE WATER AND SEWER LINE INSTALLATION ARE IN CONFLICT WITH EXISTING UTILITY POLES, GUY WIRES OR SIMILAR STRUCTURES, THE CONTRACTOR SHALL COORDINATE WITH THE UTILITY COMPANY TO DETERMINE WHETHER THE STRUCTURES WILL REQUIRE RESTRAINT. THE FINAL DECISION AS TO
- WHETHER RESTRAINT IS REQUIRED WHILE EXCAVATION OCCURS SHALL BE THAT OF THE UTILITY OWNER. THE COST FOR THIS COORDINATION AND RESTRAINT SHALL BE INCLUDED IN THE CONTRACTOR'S OVERALL COSTS.
- CONTRACTOR SHALL PROVIDE TEMPORARY CONNECTIONS AS NECESSARY FOR FLUSHING, DECONTAMINATION AND PRESSURE TESTING.
- RPZ-BPA ON WATER SERVICE LINES TO BE TESTED AND APPROVED BY HCUD. TO BE INSTALLED PER HCUD DETAIL #7 AND TESTED BY A LICENSED PLUMBER WITH TEST RESULTS PROVIDED TO HCUD'S BPA INSPECTOR. CONTACT INSPECTOR AT (352) 754-4158.
- ALL DEFLECTION BENDS ARE 45° UNLESS SPECIFIED OTHERWISE. EXACT LOCATION OF BENDS TO BE DETERMINED IN FIELD AND APPROVED BY FIELD INSPECTOR. LOCATION DATA SHALL BE PROVIDED IN AS-BUILTS ACCORDING TO COUNTY REQUIREMENT

APPROX

ARCH.

ASTM

THE FOLLOWING ABBREVIATIONS ARE USED ON THESE PLAN

AVFRAGE

RUIINDAR

BUILDING

RNIIARN

BEARING

BASEMENT

CORF

CAPACITY

CATCH BASIN

CENTERLINE

CUBIC FEET

CONTROL JOINT CRUSHED LIMESTON

CENTERLINE

CI FAN NIIT COEFFICIENT

COLUMN

CONCRETE

CONNECTION

CUBIC YARD DIAMETER

DUCTILE IRON

DIMENSION

DEMOLITION

DEPARTMENT

DOWNSPOUT

FACH

EAST

EACH END

FI FVATION

ENGINEER

ENTRANCE

EQUIPMEN[®]

EXCAVATE

EXISTING

EXPANSION

FLOOR DRAIN

FOUNDATION

FINISH FLOOR

FINISH GRADE

FLOOD PLAIN

FEET/FOOT FOOTING

FIFVATION

EOUIPMEN

GALLON

GENERAL

GUTTER

GRAVEL

GATE VALVE

HFAVY DIITY

HANDHOLE

HIGH POINT HYDRAULIC GRADE LINE

HORIZONTAL

HYDRANT

INSTALL

LIGHT DUTY LINEAR FEET

LOW POINT

MAXIMUM

MANHOLE

MINIMUM

NIIMRFR

NORTH

MATCH FXISTING

NOT IN CONTRACT

NOT FIELD VERIFIED

NUTSIDE DIAMETER

POLYVINYL CHLORIDE

REINFORCED CONCRETE PIPE

PORTLAND CEMENT CONCRETE = CONCRETE

NOT TO SCALE

ON CENTER

PROPOSED

REAR YARD

HORIZ/HORIZ.

MIN/MIN

HYD

FIIRNISH

FIRE DEPARTMENT CONNECTION

GEOGRAPHIC INFORMATION SYSTEM

HIGH DENSITY POLYETHYLENE

HOT MIX ASPHALT PAVEMENT

FULL DEPTH RECLAMATION

FI ORIDA DEPARTMENT OF TRANSPORTATION

END SECTION

EDGE OF GRAVE

EDGE OF METAL

ELECTRICAL HAND HOLE

DROP MANHOL

DEGREE

DUCTILE IRON PIPE

COVER

CULVERT

COMMUNICATIONS

CORRUGATED METAL PIPE

CONCRETE MASONRY UNIT

CORRIIGATED PLASTIC PIP

CHANNFI

BOTTOM OF WAL

BOTTOM

BENCHMARK

RITIIMINNIIS

BARRIFR FRFF

BANK FULL FLOOD

CUWW/CUWM CONC. COV. CULV DIA/DIA пім/пім DEG/DEG. DEMO/DEMO. ENG/ENG. ENT. EOUIP. EXCAV/EXCAV EX/EX. GAL/GAL. GEN. GIS GV/GV/

THE FOLLOWING DEFINITIONS ARE USED ON THESE PLANS: SPRING HILL HERNANDO

ENGINEER

CITY

COUNTY

CLIENT

ABBREVIATIONS USED IN DRAWINGS

AT (RATE OF) ΑΝΠ INCH ASPHALT CONCRETE = ASPHALT PAVEMENT/HOT MIX ASPHALT PAVEMENT AMERICANS WITH DISABILITIES ACT (BARRIER FREE ACCESS) AGGREGATE BASE ALTERNATE APPROXIMATE/APPROXIMATELY ARCHITECT AMERICAN SOCIETY FOR TESTING AND MATERIALS


TYP/TYP VOL

SANITARY SEWER STABILIZED BASE COURSE SOIL EROSION AND SEDIMENT CONTRO SOLIARE FEFT SUBGRADE STORM SEWER SOUARE YARD TOP OF HMA PAVEMENT FLEVATION TOP OF PROPOSED CURB TEMPORARY FARTH RETENTION SYSTEM TOP OF PAD (CONCRETE) TOP OF WALL TEST PIT TYPICAL TOP OF SIDEWALK VAPOR BARRIER **VITRIFIED CLAY PIPE** VFRTICAL VERIFY IN FIELD VAULT VOLUME WEST

WATER MAIN

WELDED WIRE FABRIC

WATER

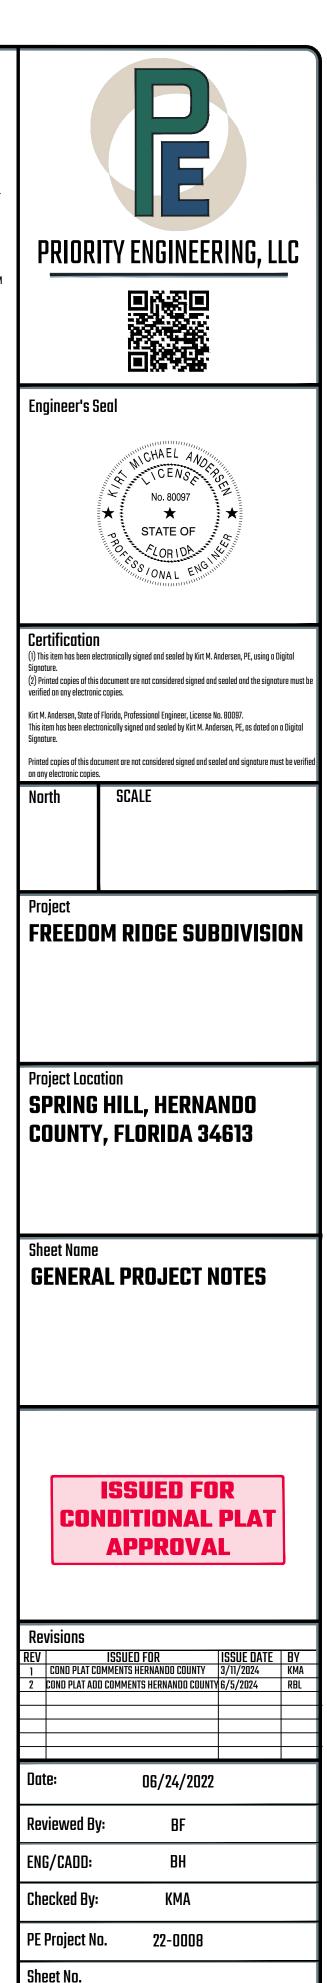


G-100

AWING NOTE: SCALE SHOWN IS MEANT FOR 22" X 34" AND WILL SCALE INCORRECT TION SHALL BE MADE WITHOUT PRIOR CONSENT OF PRIC

PRIORITY ENGINEERING, LLC

PARAGON PROPERTY GROUP

VFRT/VFR WTF

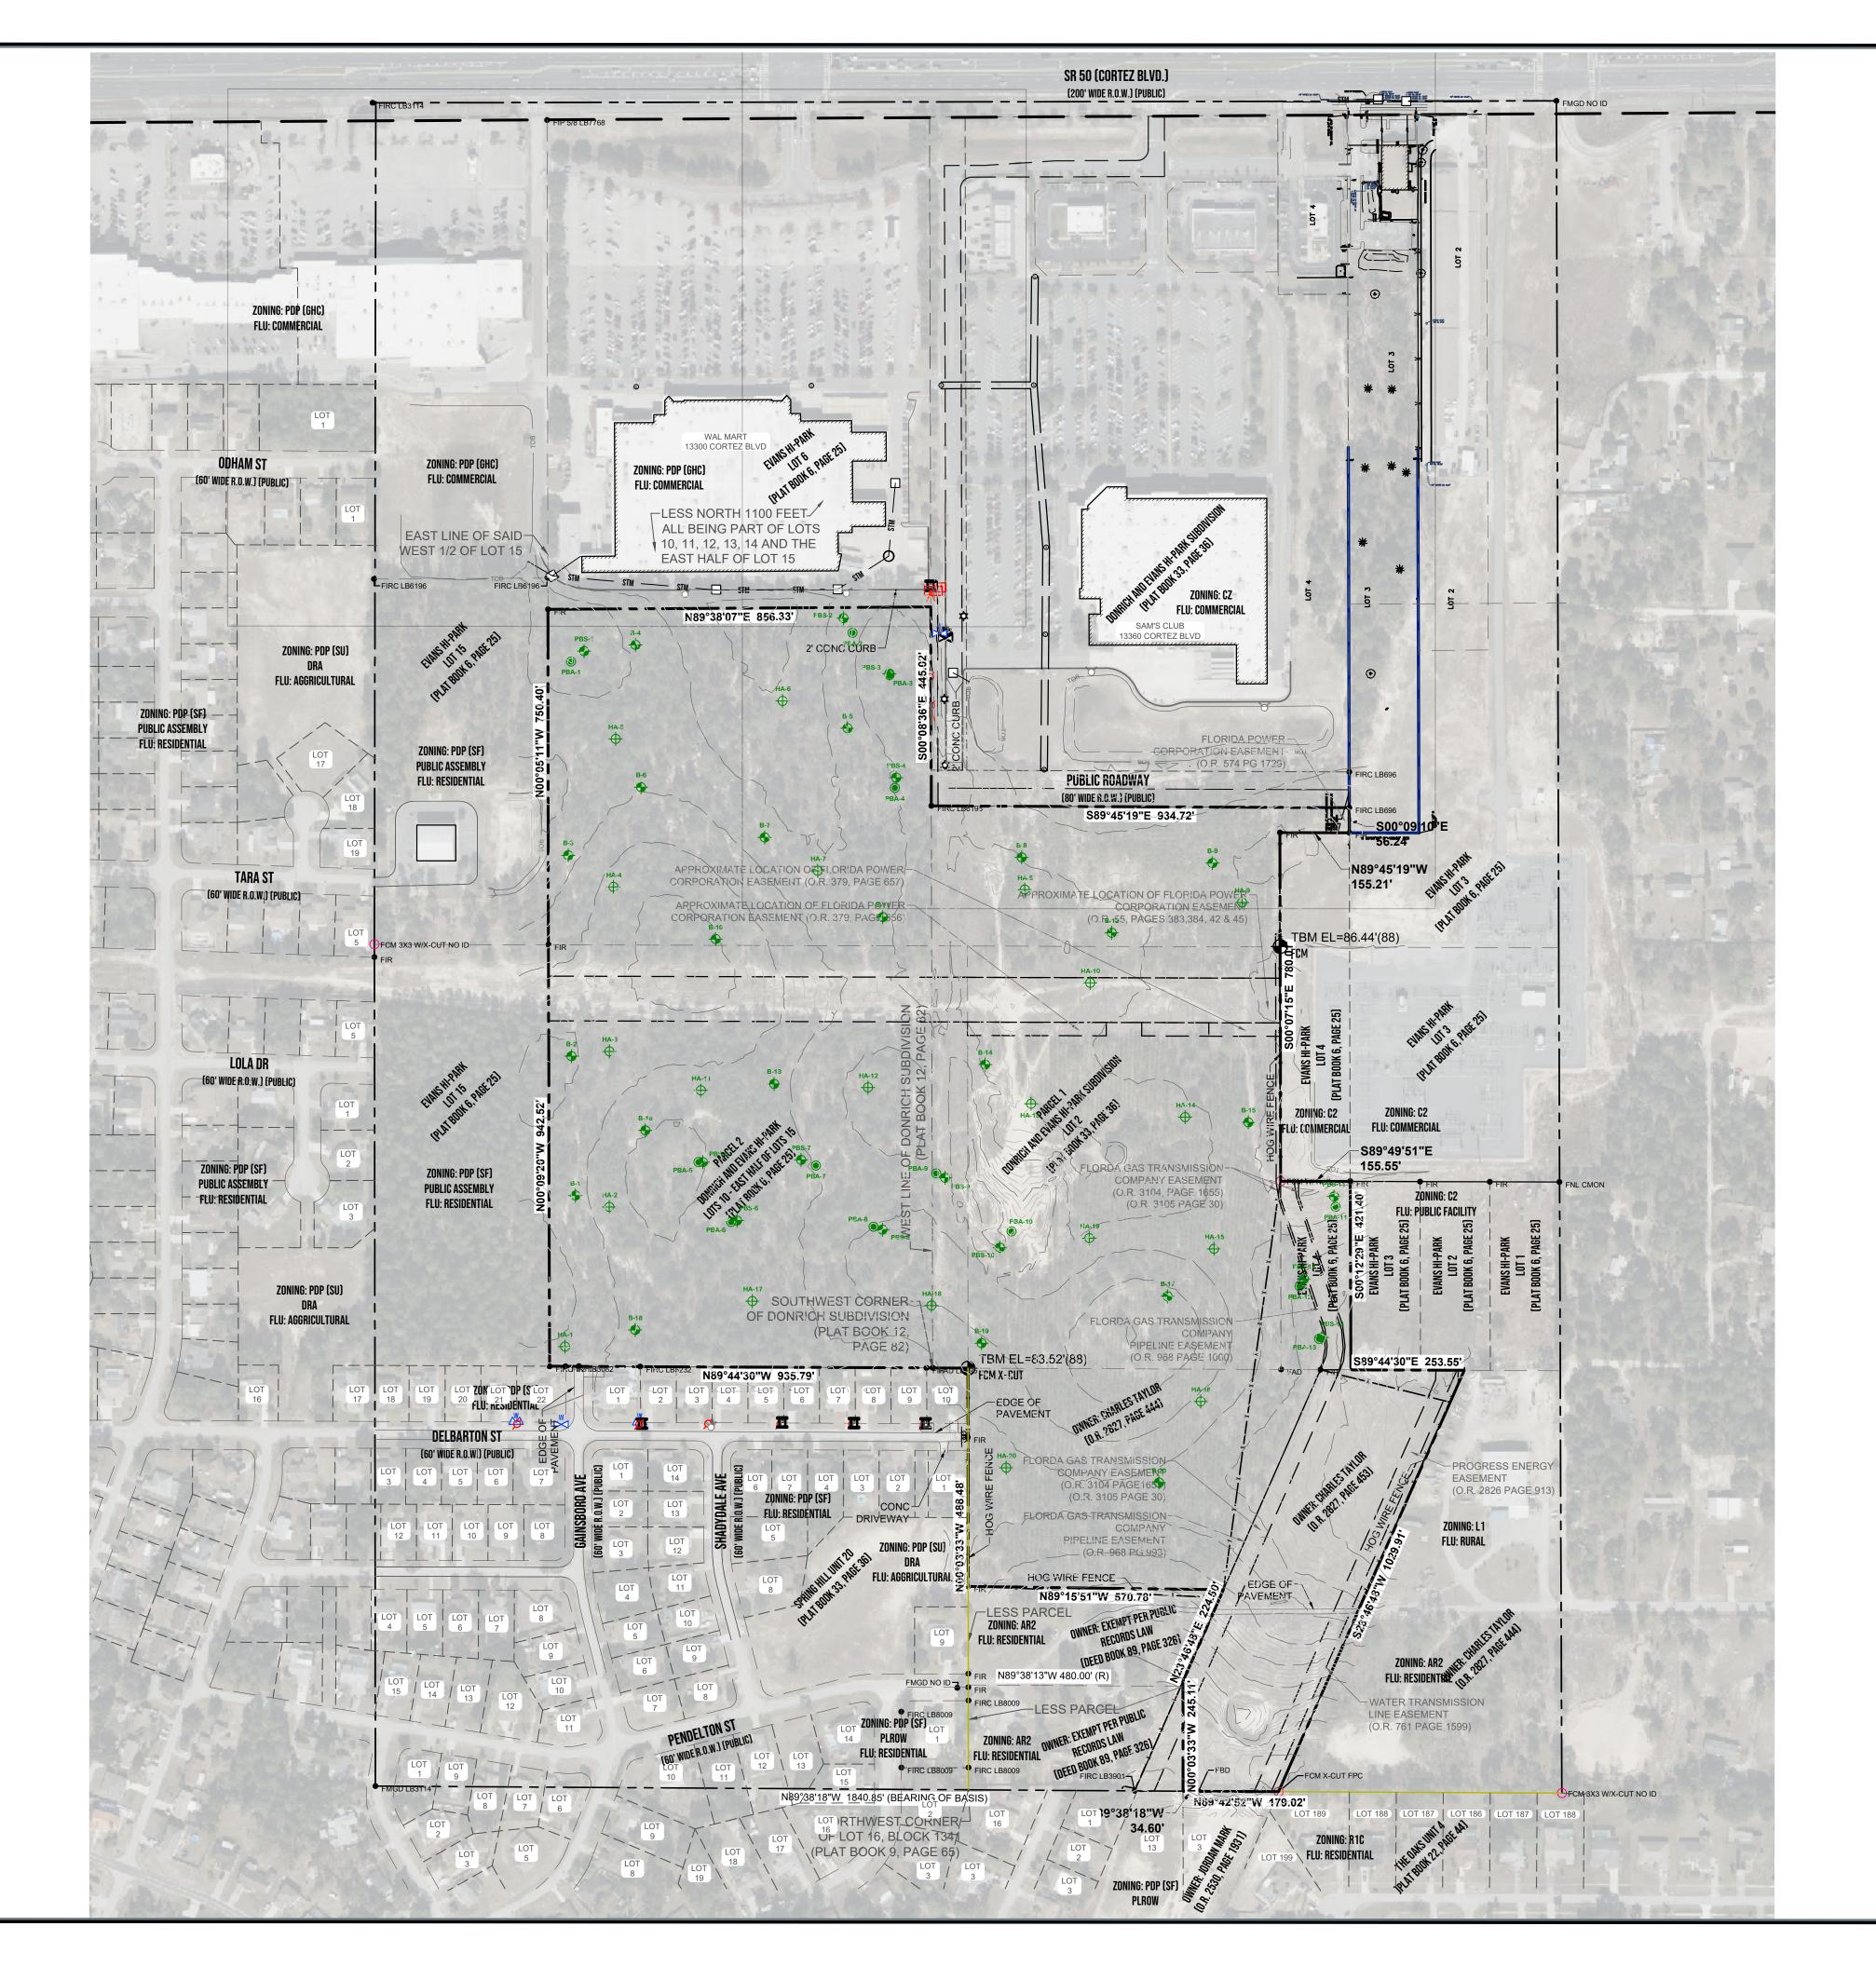

Official Records Bool Licensed Business Concrete Flevation Invert Found Aluminum Disk Found Brass Disk Found Nail Concrete Monument Found Iron Rod Found Conc. Monumen Transformer With Cable Pedestal Telephone Pedestal Utility Pole Guy Anchor Light Pole Water Valve Water Meter

Utility Valve Electric Box Overhead Utility Lines Temporary Benchmark

NOTES

BENCHMARK DATA:

BM A NORTHING: EASTING: ELEVATION: (NAVD88 DATUM)

BM B NORTHING: EASTING: ELEVATION: (NAVD88 DATUM)

LEGAL DESCRIPTION:

PARCEI 1:

PARCEL 2:

BEGINNING AT THE SOUTHWEST CORNER OF THE SOUTHEAST 1/4 OF THE SOUTHEAST 1/4 OF SAID SECTION 33, TOWNSHIP 22 SOUTH, RANGE 18 EAST; RUN NORTH 234.5 FEET; THENCE EAST 480 FEET; THENCE SOUTH 234.5 FEET; THENCE WEST 480 FEET TO THE POINT OF BEGINNING. ALSO LESS THE FOLLOWING DESCRIBED PARCEL:

ALSO LESS THE FOLLOWING DESCRIBED PARCEL: THAT PORTION OF THE SOUTHEAST 1⁄4 OF THE SOUTHEAST 1⁄4 OF SECTION 33, TOWNSHIP 22 SOUTH, RANGE 18 EAST, HERNANDO COUNTY, FLORIDA, LYING EASTERLY OF THE FLORIDA POWER CORPORATION EASEMENT BEING DESCRIBED IN OFFICIAL RECORDS BOOK 110, PAGE 244, OF THE PUBLIC RECORDS OF HERNANDO COUNTY, FLORIDA.


LEGAL DESCRIPTION: (PARAGON ACQUISITIONS)

THE LAND REFERRED TO HEREIN BELOW IS SITUATED IN THE COUNTY OF HERNANDO, STATE OF FLORIDA, AND DESCRIBED AS FOLLOWS: COMMENCE AT THE NE CORNER OF THE WEST 1/2 OF LOT 15 OF EVANS HI PARK SUBDIVISION, AS PER PLAT THEREOF, RECORDED IN PLAT BOOK 6, PAGE 25, OF THE PUBLIC RECORDS OF HERNANDO COUNTY, FLORIDA; THENCE RUN SOUTH ALONG THE EAST LINE OF SAID WEST 1/2 OF LOT 15 TO THE SOUTH LINE OF SAID SUBDIVISION (BEING THE SE CORNER OF THE WEST 1/2 OF SAID LOT 15): THENCE RUN EAST TO THE SW CORNER OF DONRICH SUBDIVISION, AS RECORDED IN PLAT BOOK 12, PAGE 82, OF THE PUBLIC RECORDS OF HERNANDO COUNTY, FLORIDA; THENCE RUN NORTH ALONG THE WEST LINE OF SAID DONRICH SUBDIVISION TO THE SOUTH RIGHT OF WAY OF STATE ROAD 50 (BEING THE NW CORNER OF SAID DONRICH SUBDIVISION AND WEST OF THE POINT OF BEGINNING); THENCE RUN WEST ALONG THE SOUTH RIGHT OF WAY OF STATE ROAD 50 TO THE POINT OF BEGINNING. SUBJECT TO INTERPRETATION BY THE UNITED STATES DEPARTMENT OF THE INTERIOR RULING RECORDED IN DEED BOOK 114, PAGE 367, OF THE PUBLIC RECORDS OF HERNANDO COUNTY, FI ORIDA.

LESS THE NORTH 1100 FEET THEREOF AS DESCRIBED IN WARRANTY DEED RECORDED IN OFFICIAL RECORDS BOOK 1048, PAGE 1159, OF THE PUBLIC RECORDS OF HERNANDO COUNTY, FLORIDA.

FI ORIDA.

EXISTING LEGEND

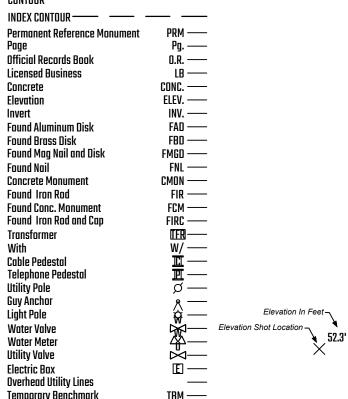

 DRAWING BASED ON MICHIGAN STATE PLAN COORDINATES SYSTEM, SOUTH ZONE, INTERNATIONAL FEET.

 THIS SURVEY WILL NOT SHOW ALL EASEMENTS OF RECORD UNTIL AN UPDATED TITLE POLICY HAS BEEN FURNISHED TO THE SURVEYOR BY THE OWNER.

ALL ELEVATIONS ARE EXISTING ELEVATIONS

 THE LOCATION OF THE EXISTING UTILITIES AS SHOWN WERE OBTAINED FROM MUNICIPAL AND UTILITY COMPANIES RECORDS. NO GUARANTEE CAN BE MADE REGARDING THE COMPLETENESS OR EXACTNESS OF THE UTILITIES LOCATION. IT IS THE CONTRACTORS RESPONSIBILITY TO VERIFY IN THE FIELD THE LOCATION OF ALL UTILITIES.

• NO BOUNDARY SURVEY WAS PERFORMED.

BENCH TIE EAST FACE OF LP

BENCH TIE EAST FACE OF LP

THE LAND REFERRED TO HEREIN BELOW IS SITUATED IN THE COUNTY OF HERNANDO, STATE OF FLORIDA, AND DESCRIBED AS

LOT 2 OF DONRICH AND EVANS HI-PARK SUBDIVISION, ACCORDING TO THE PLAT THEREOF AS RECORDED IN PLAT BOOK 33, PAGES 36 AND 37, OF THE PUBLIC RECORDS OF HERNANDO COUNTY, FLORIDA.

THE SOUTHEAST 1/4 OF THE SOUTHEAST 1/4 OF SECTION 33, TOWNSHIP 22 SOUTH, RANGE 18 EAST, HERNANDO COUNTY, FLORIDA.


LESS THE FOLLOWING DESCRIBED PARCEL:

COMMENCE AT THE SOUTHWEST CORNER OF THE SOUTHEAST 1/4 OF THE SOUTHEAST 1/4 OF SECTION 33, TOWNSHIP 22 SOUTH, RANGE 18 EAST. HERNANDO COUNTY. FLORIDA. SAID POINT OF COMMENCEMENT BEING ALSO THE NORTHWEST CORNER OF LOT 16. BLOCK 1341, SPRING HILL UNIT 20, AS RECORDED IN PLAT BOOK 9, PAGES 65-80, INCLUSIVE, PUBLIC RECORDS OF HERNANDO COUNTY, FLORIDA: THENCE NORTH OD®O7'10" WEST ALONG THE WEST LINE OF SAID SOUTHEAST 1/4 OF THE SOUTHEAST 1/4 AND ALONG THE EAST LINE OF SAID SPRING HILL UNIT 20, A DISTANCE OF 234.50 FEET TO THE POINT OF BEGINNING; THENCE CONTINUE NORTH 00°07'10" WEST, A DISTANCE OF 220.35 FEET; THENCE SOUTH 89°19'28" EAST, A DISTANCE OF 562.93 FEET TO THE WESTERLY RIGHT-OF-WAY LINE OF THE FLORIDA POWER CORPORATION EASEMENT AS IT NOW EXISTS; THENCE SOUTH 23°44'27" WEST ALONG SAID WESTERLY RIGHT-OF-WAY LINE, A DISTANCE OF 203.41 FEET; THENCE SOUTH 00°07'10" EAST, A DISTANCE OF 10.91 FEET; THENCE NORTH 89°38'13" WEST, A DISTANCE OF 480.00 TO THE POINT OF BEGINNING.

TOGETHER WITH ALL OF GRANTOR'S RIGHTS IN THE EASEMENT OVER A PORTION OF VACATED LOT 15 OF SAID EVANS HI PARK SUBDIVISION, AS DESCRIBED IN EASEMENT FOUND IN DEED RECORDED IN OFFICIAL RECORDS BOOK 1048, PAGE 1159, AND EASEMENTS RECORDED IN BOOK 1048, PAGE 1166 AND BOOK 1048, PAGE 1169, OF THE PUBLIC RECORDS OF HERNANDO COUNTY,

ALL BEING A PART OF LOTS 10, 11, 12, 13, 14 AND THE EAST 1/2 OF LOT 15, EVANS HI PARK SUBDIVISION, AS PER MAP OR PLAT THEREOF, AS RECORDED IN PLAT BOOK 6, PAGE 25, AND AS VACATED IN OFFICIAL RECORDS BOOK 1047, PAGE 363, AS CORRECTED BY INSTRUMENT RECORDED IN OFFICIAL RECORDS BOOK 1050, PAGE 1238, OF THE PUBLIC RECORDS OF HERNANDO COUNTY, FLORIDA.



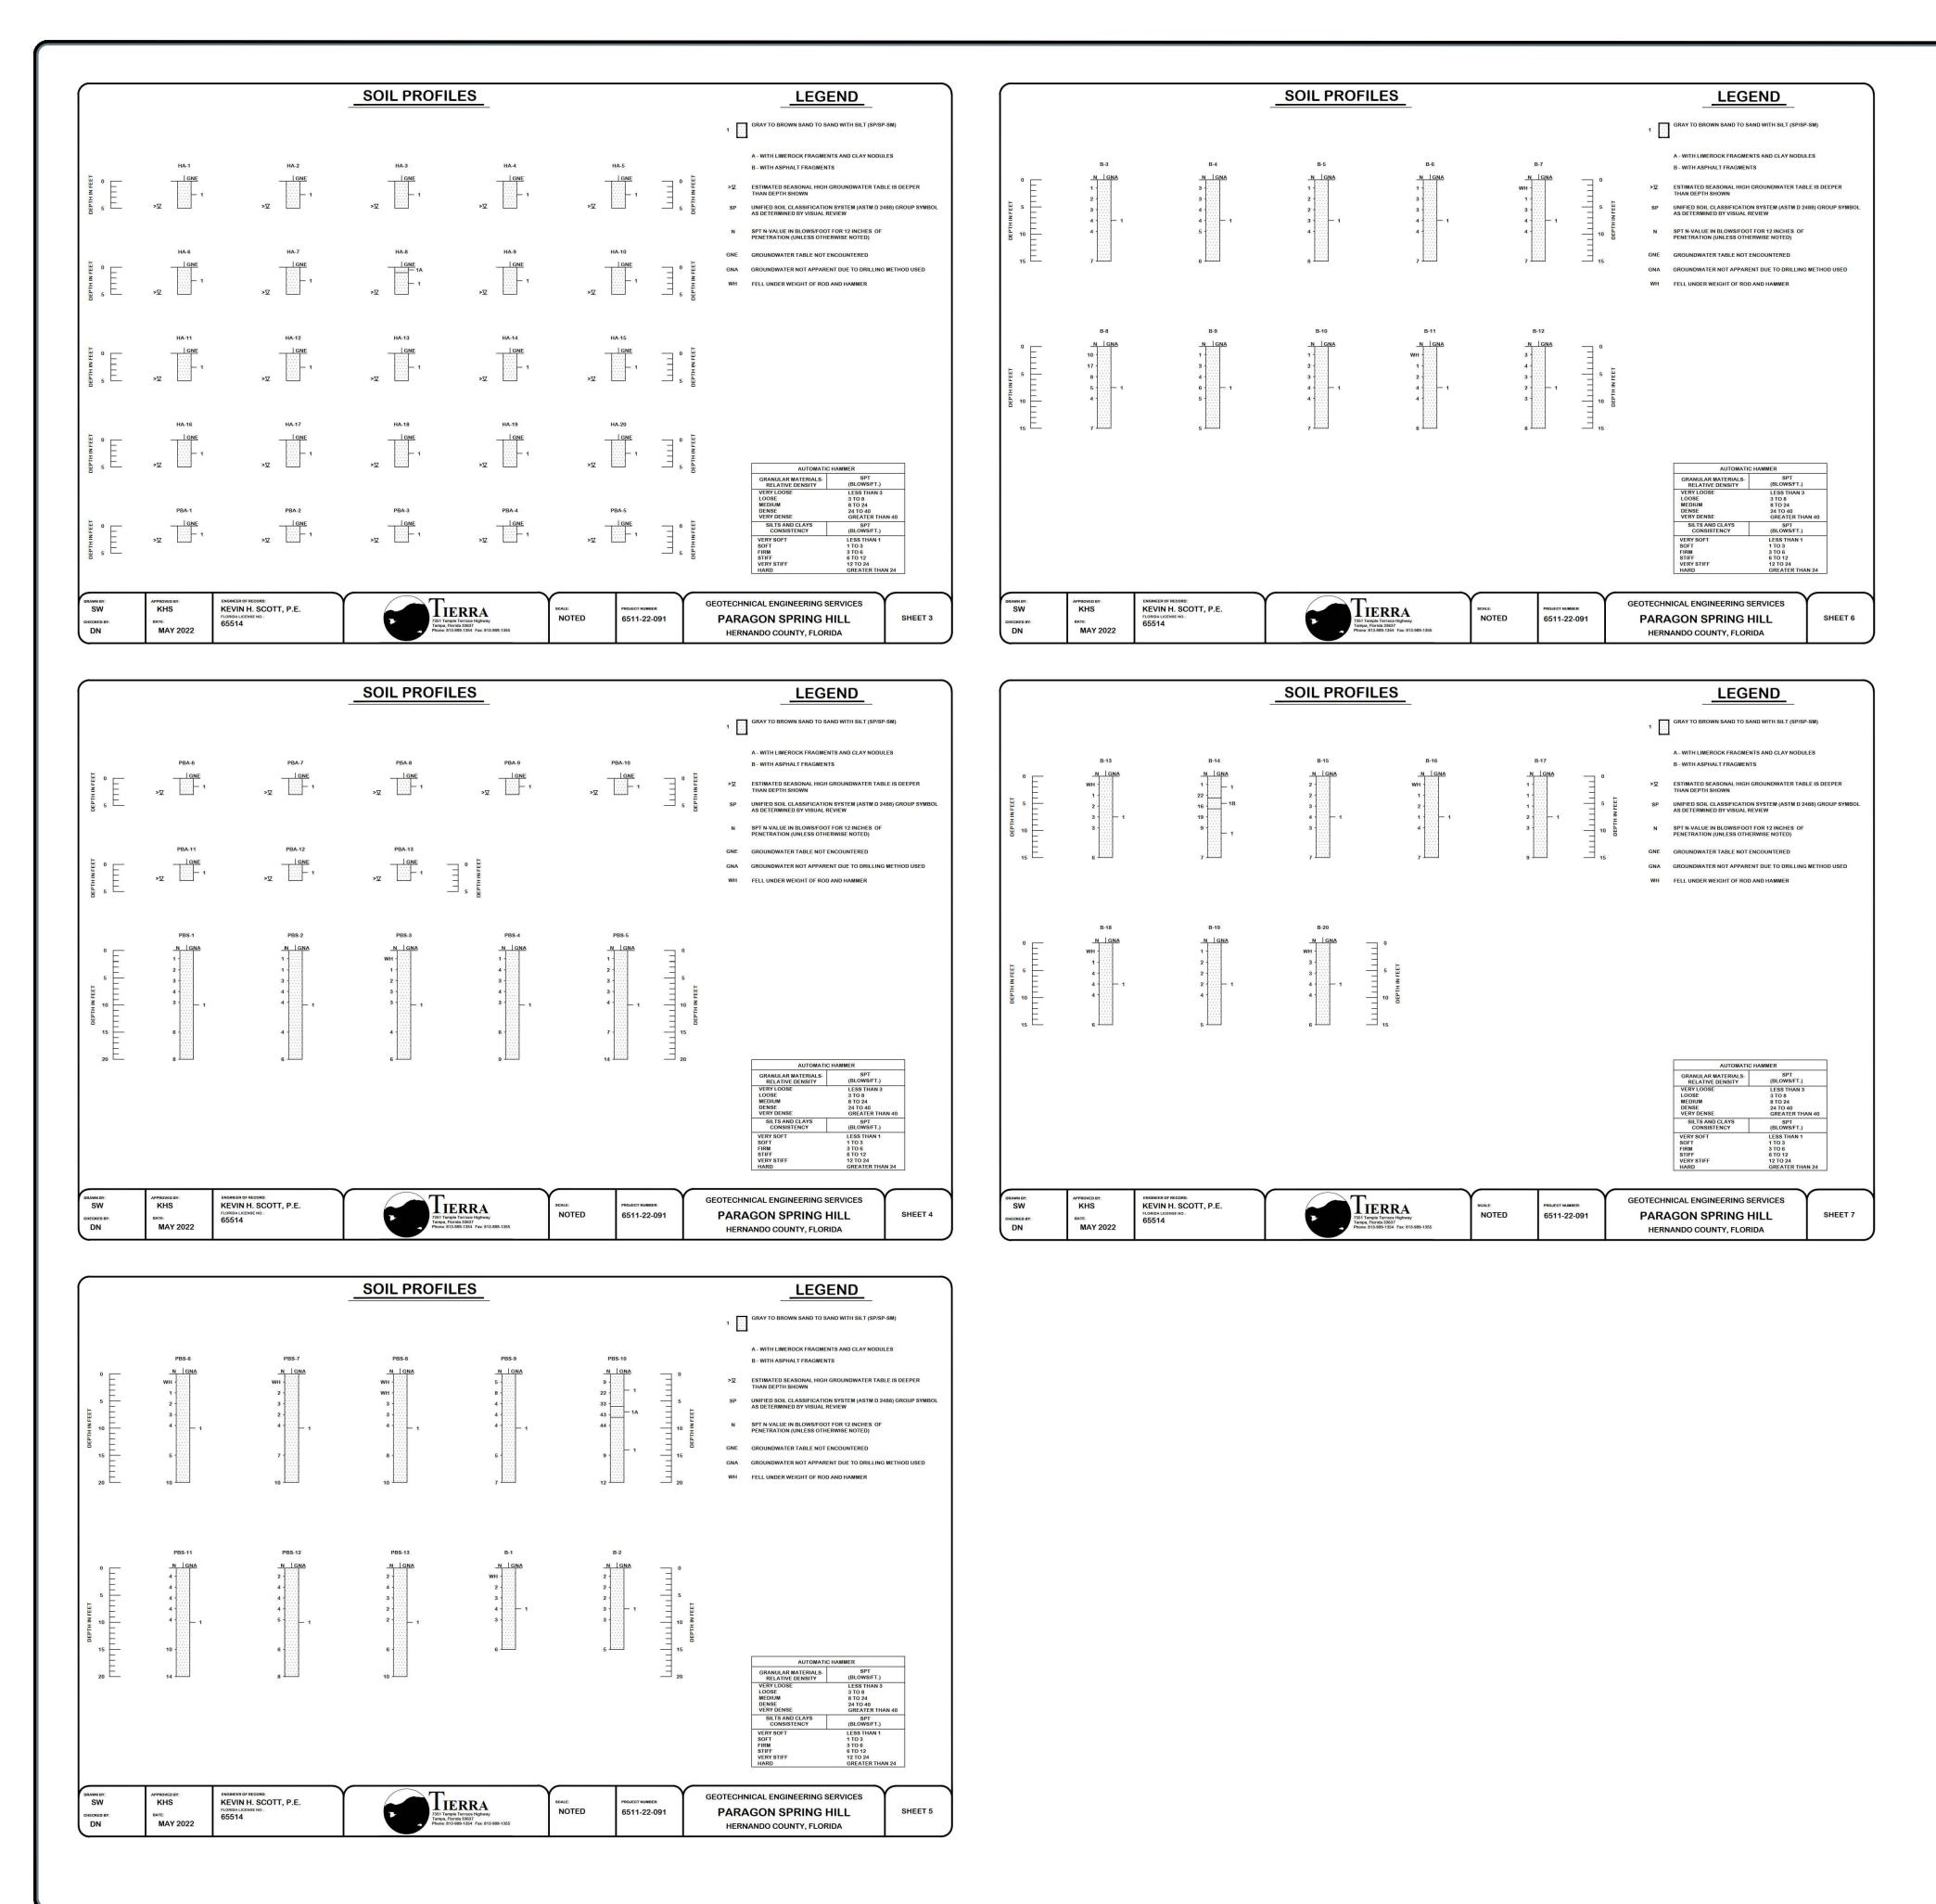

						5	Hernand	eotechnical P Ion Spring Hi o County, Flo ect No. 6511-	l rida					
	Boring L	ocation ⁽¹⁾		Meas Groundwa			County USDA urvey Data	Estimated		Fie	ld Permeability Test Resu	lts		
Boring Name	Easting	Northing	Boring Depth (ft)	Date Recorded	Depth (ft)	Map Unit	Estimated SHGWT Depth (ft)	SHGWT Depth ⁽²⁾ (ft)	Test Depth (ft)	Stratum Tested	In-Situ Horizontal Hydraulic Conductivity Rate, k _h ⁽³⁾ (feet/dav)	In-Situ Vertical Hydraulic Conductivity Rate, k _v ⁽³⁾ (feet/day)	Confining Layer Depth (ft)	Soil Porosi (%)
3994-0392	2 (#2000) (1000)			h di	5-1-10 March			POND	12150					4
PBA-1	493441	1525759	3.0	4/20/2022	GNE ⁽⁴⁾	14	> 6.0	> 6.0 POND	3.0	1	40	40	> 20	30
PBA-2	494071	1525824	3.0	4/20/2022	GNE ⁽⁴⁾	14	> 6.0	> 6.0	3.0	1	40	40		
PBA-3	494154	1525729	3.0	4/20/2022	GNE ⁽⁴⁾	14	> 6.0	> 6.0	3.0	1	40	40	>20	30
PBA-4	494166	1525477	3.0	4/20/2022	GNE ⁽⁴⁾	14	> 6.0	> 6.0	3.0	1	40	40		
1 2011	101100	1020111	0.0	WIGHTONE	GIVE			POND	0.0			199		L
PBA-5	493726	1524640	3.0	4/19/2022	GNE ⁽⁴⁾	14	> 6.0	> 6.0	3.0	1	40	40		8
PBA-6	493800	1524506	3.0	4/19/2022	GNE ⁽⁴⁾	14	> 6.0	> 6.0	3.0	1	40	40		
PBA-7	493989	1524632	3.0	4/19/2022	GNE ⁽⁴⁾	14	> 6.0	> 6.0	3.0	1	40	40	. 20	20
PBA-8	494118	1524495	3.0	4/20/2022	GNE ⁽⁴⁾	14	> 6.0	> 6.0	3.0	1	40	40	>20	30
PBA-9	494258	1524614	3.0	4/20/2022	GNE ⁽⁴⁾	14	> 6.0	> 6.0	3.0	1	40	40		
PBA-10	494427	1524485	3.0	4/20/2022	GNE ⁽⁴⁾	14	> 6.0	> <u>6</u> .0	3.0	1	38	38		
		S						POND						4
PBA-11	495151	1524540	3.0	4/20/2022	GNE ⁽⁴⁾	41		> 6.0	3.0	1	40	40		
PBA-12	495071	1524362	3.0	4/20/2022	GNE ⁽⁴⁾	14	> 6.0	> 6.0	3.0	1	40	40	>20	30
PBA-13	495114	1524244	3.0	4/20/2022	GNE ⁽⁴⁾	14	> 6.0	> 6.0	3.0	1	40	40		


						2	Hernand	on Spring Hil on Spring Hil o County, Flo ect No. 6511-2	l rida					
	Boring L	ocation ⁽¹⁾		Meas Groundwa			County USDA urvey Data	Estimated		Fie	eld Permeability Test Resu	lts		
loring Name	Easting	Northing	Boring Depth (ft)	Date Recorded	Depth (ft)	Map Unit	Estimated SHGWT Depth (ft)	SHGWT Depth ⁽²⁾ (ft)	Test Depth (ft)	Stratum Tested	In-Situ Horizontal Hydraulic Conductivity Rate, k _h ⁽³⁾ (feet/day)	In-Situ Vertical Hydraulic Conductivity Rate, k _v ⁽³⁾ (feet/day)	Confining Layer Depth (ft)	Soil Poros (%)
				******				ROADWAY						
HA-1	493428	1524227	5.0	4/15/2022	GNE ⁽⁴⁾	14	> 6.0	> 5.0						
HA-2	493527	1524539	5.0	4/15/2022	GNE ⁽⁴⁾	14	> 6.0	> 5.0						
HA-3	493527	1524887	5.0	4/15/2022	GNE ⁽⁴⁾	14	> 6.0	> 5.0						
HA-4	493534	1525255	5.0	4/15/2022	GNE ⁽⁴⁾	14	> 6.0	> 5.0						
HA-5	493541	1525586	5.0	4/15/2022	GNE ⁽⁴⁾	14	> 6.0	> 5.0						
HA-6	493915	1525671	5.0	4/15/2022	GNE ⁽⁴⁾	14	> 6.0	> 5.0						
HA-7	493993	1525292	5.0	4/15/2022	GNE ⁽⁴⁾	14	> 6.0	> 5.0						
HA-8	494456	1525249	5.0	4/15/2022	GNE ⁽⁴⁾	14	> 6.0	> 5.0						
HA-9	494942	1525221	5.0	4/15/2022	GNE ⁽⁴⁾	14	> 6.0	> 5.0						
HA-10	494602	1525041	5.0	4/15/2022	GNE ⁽⁴⁾	14	> 6.0	> 5.0						
HA-11	493732	1524800	5.0	4/15/2022	GNE ⁽⁴⁾	14	> 6.0	> 5.0			NOT	TESTED		
HA-12	494106	1524807	5.0	4/15/2022	GNE ⁽⁴⁾	14	> 6.0	> 5.0						
HA-13	494470	1524770	5.0	4/15/2022	GNE ⁽⁴⁾	14	> 6.0	> 5.0						
HA-14	494815	1524741	5.0	4/15/2022	GNE ⁽⁴⁾	14	> 6.0	> 5.0						
HA-15	494880	1524446	5.0	4/15/2022	GNE ⁽⁴⁾	14	> 6.0	> 5.0						
HA-16	494850	1524104	5.0	4/15/2022	GNE ⁽⁴⁾	14	> 6.0	> 5.0						
HA-17	493847	1524329	5.0	4/15/2022	GNE ⁽⁴⁾	14	> 6.0	> 5.0						
HA-18	494247	1524319	5.0	4/15/2022	GNE ⁽⁴⁾	14	> 6.0	> 5.0						
HA-19	494601	1524470	5.0	4/15/2022	GNE ⁽⁴⁾	14	> 6.0	> 5.0						
HA-20	494415	1523956	5.0	4/15/2022	GNE ⁽⁴⁾	14	> 6.0	> 5.0						


Page 1 of 2

Page 2 of 2

(4) Groundwater Not Encountered.

	PRIORITY ENGINEERING, LLC
	Enginger's Coal
	No. 80097
Signature. 0.00000000000000000000000000000000000	
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	Kirt M. Andersen, State of Florida, Professional Engineer, License No. 80097.
	Signature.
	on any electronic copies.
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Sheet No. V-101 Drawing Note: Scale shown is meant for 22" X 34" and will scale incorrectly if printed on any other size media besides 11" X 17"	PE Project No. 22-0008
ON ANY OTHER SIZE MEDIA BESIDES 11" X 17"	,
ALL REPRINTED THIS SHALL BE MADE WITHOUT OBIOD POWERLY OF PROPERTY PROVIDENCE	

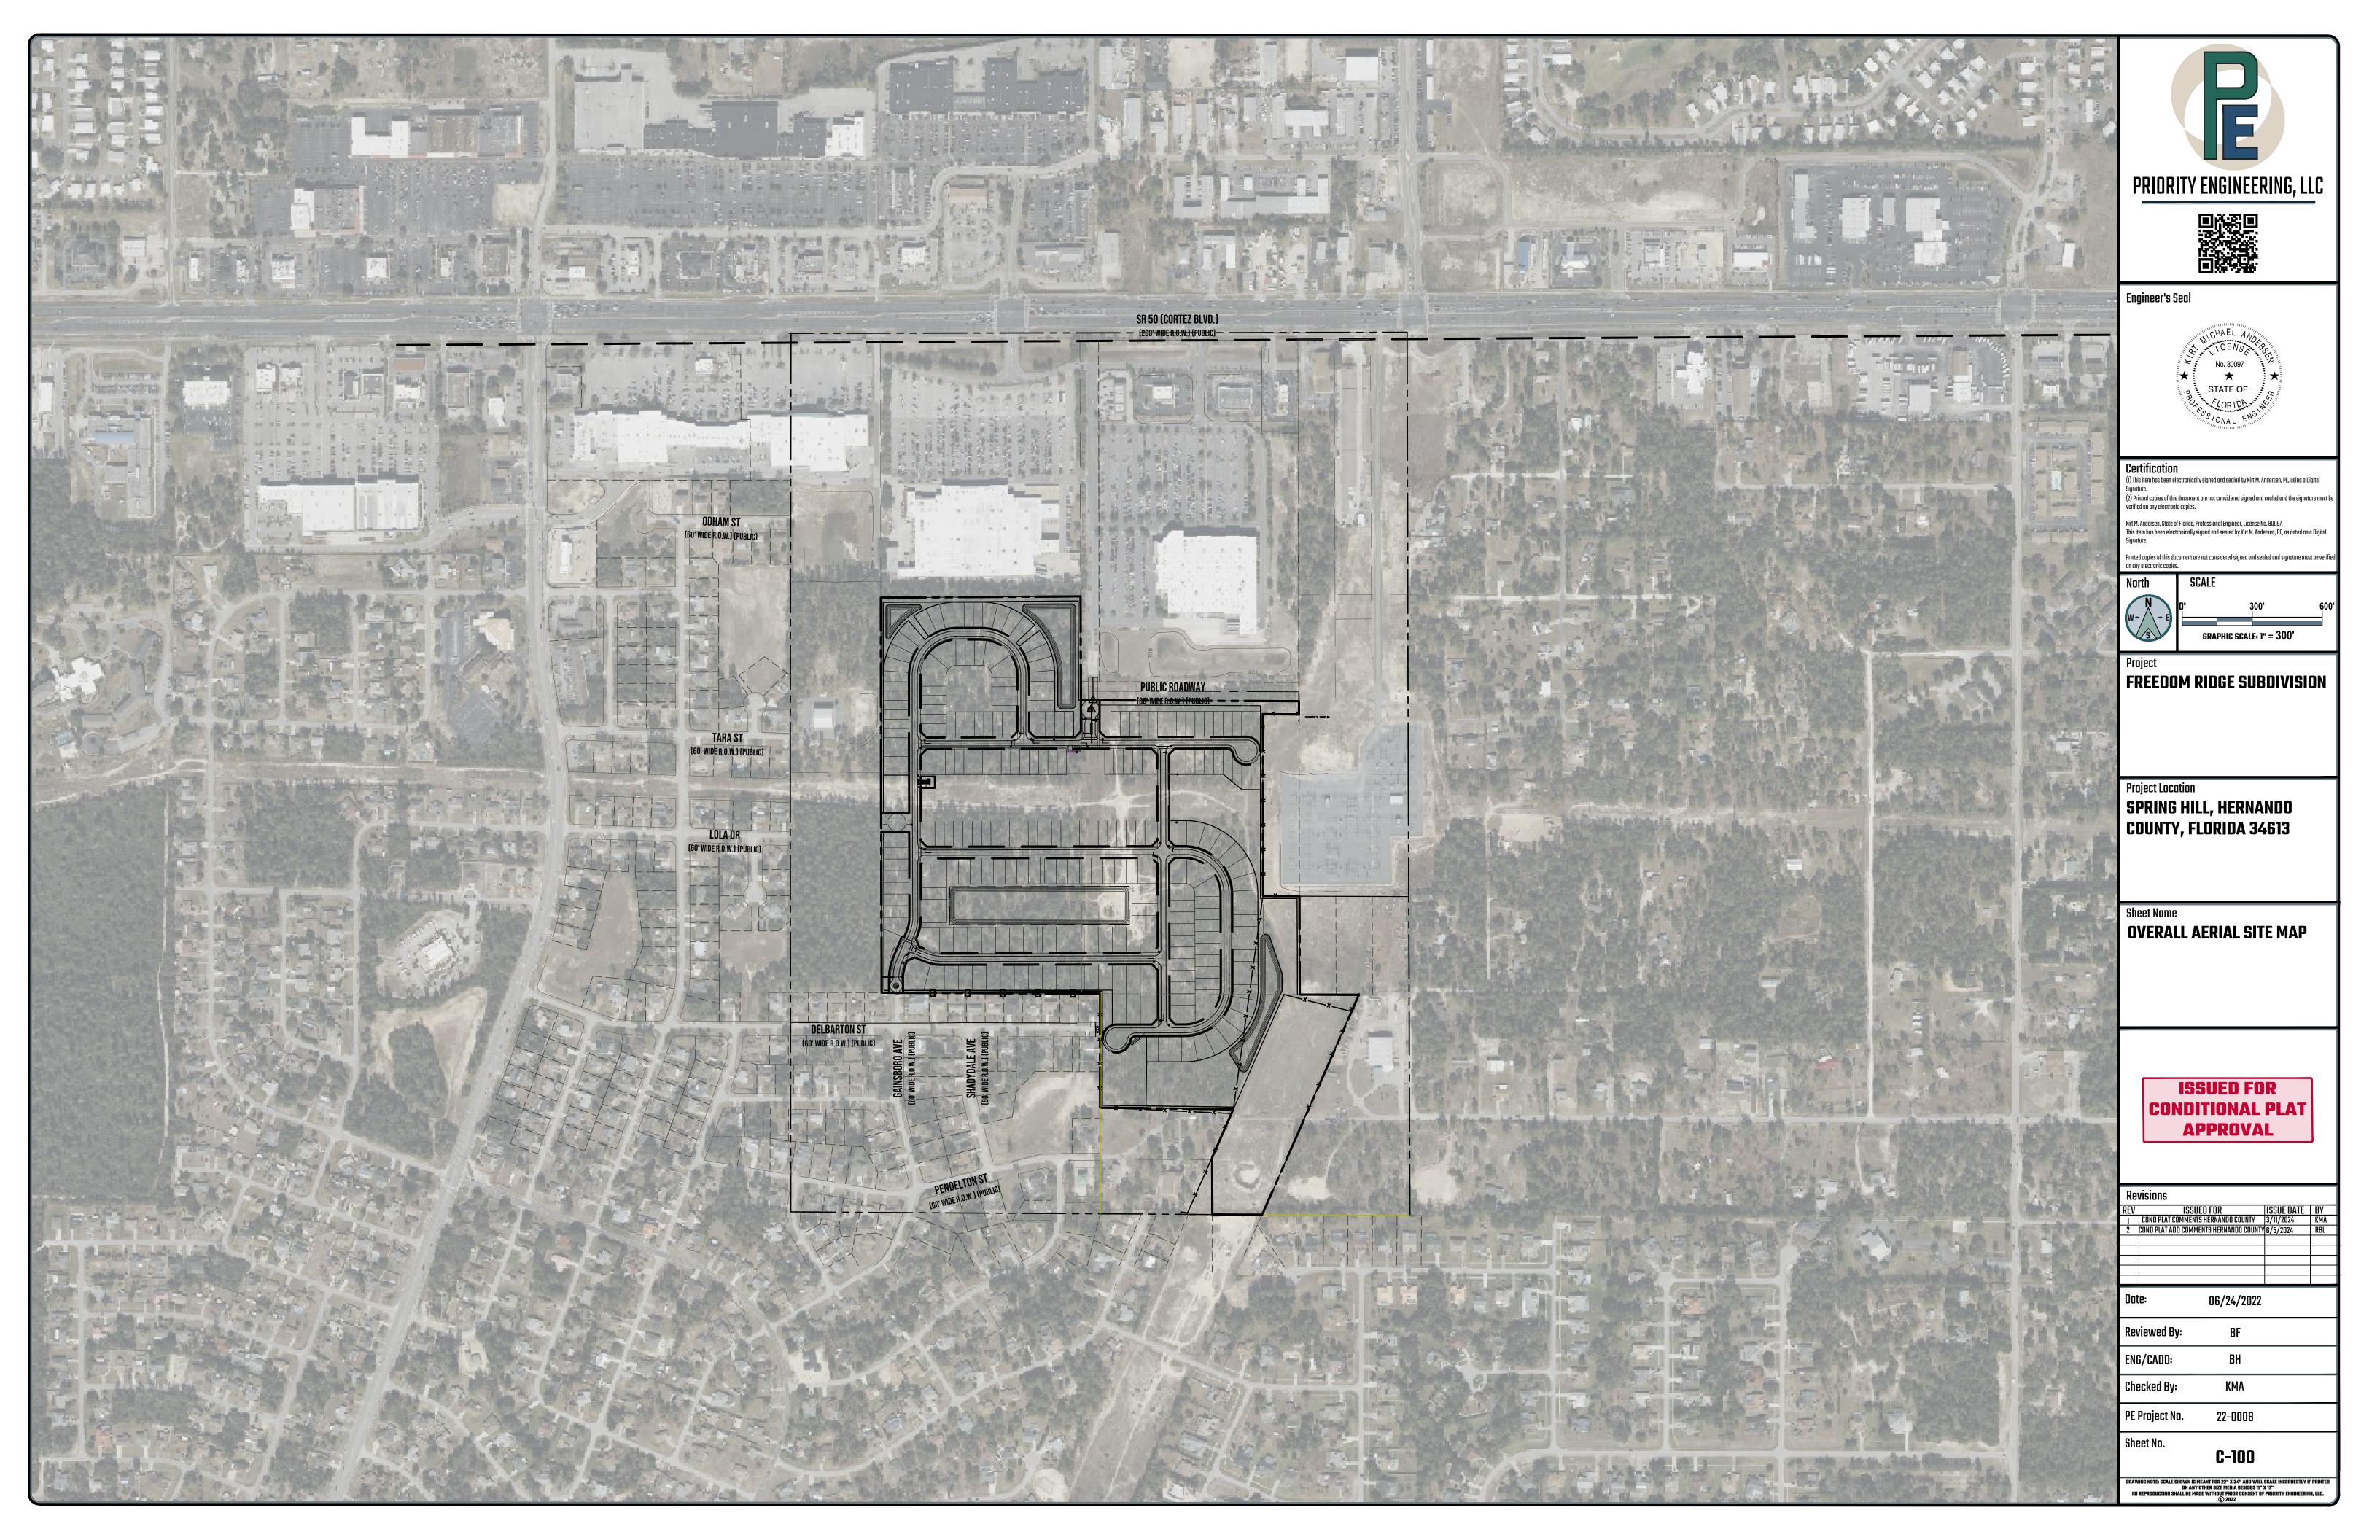

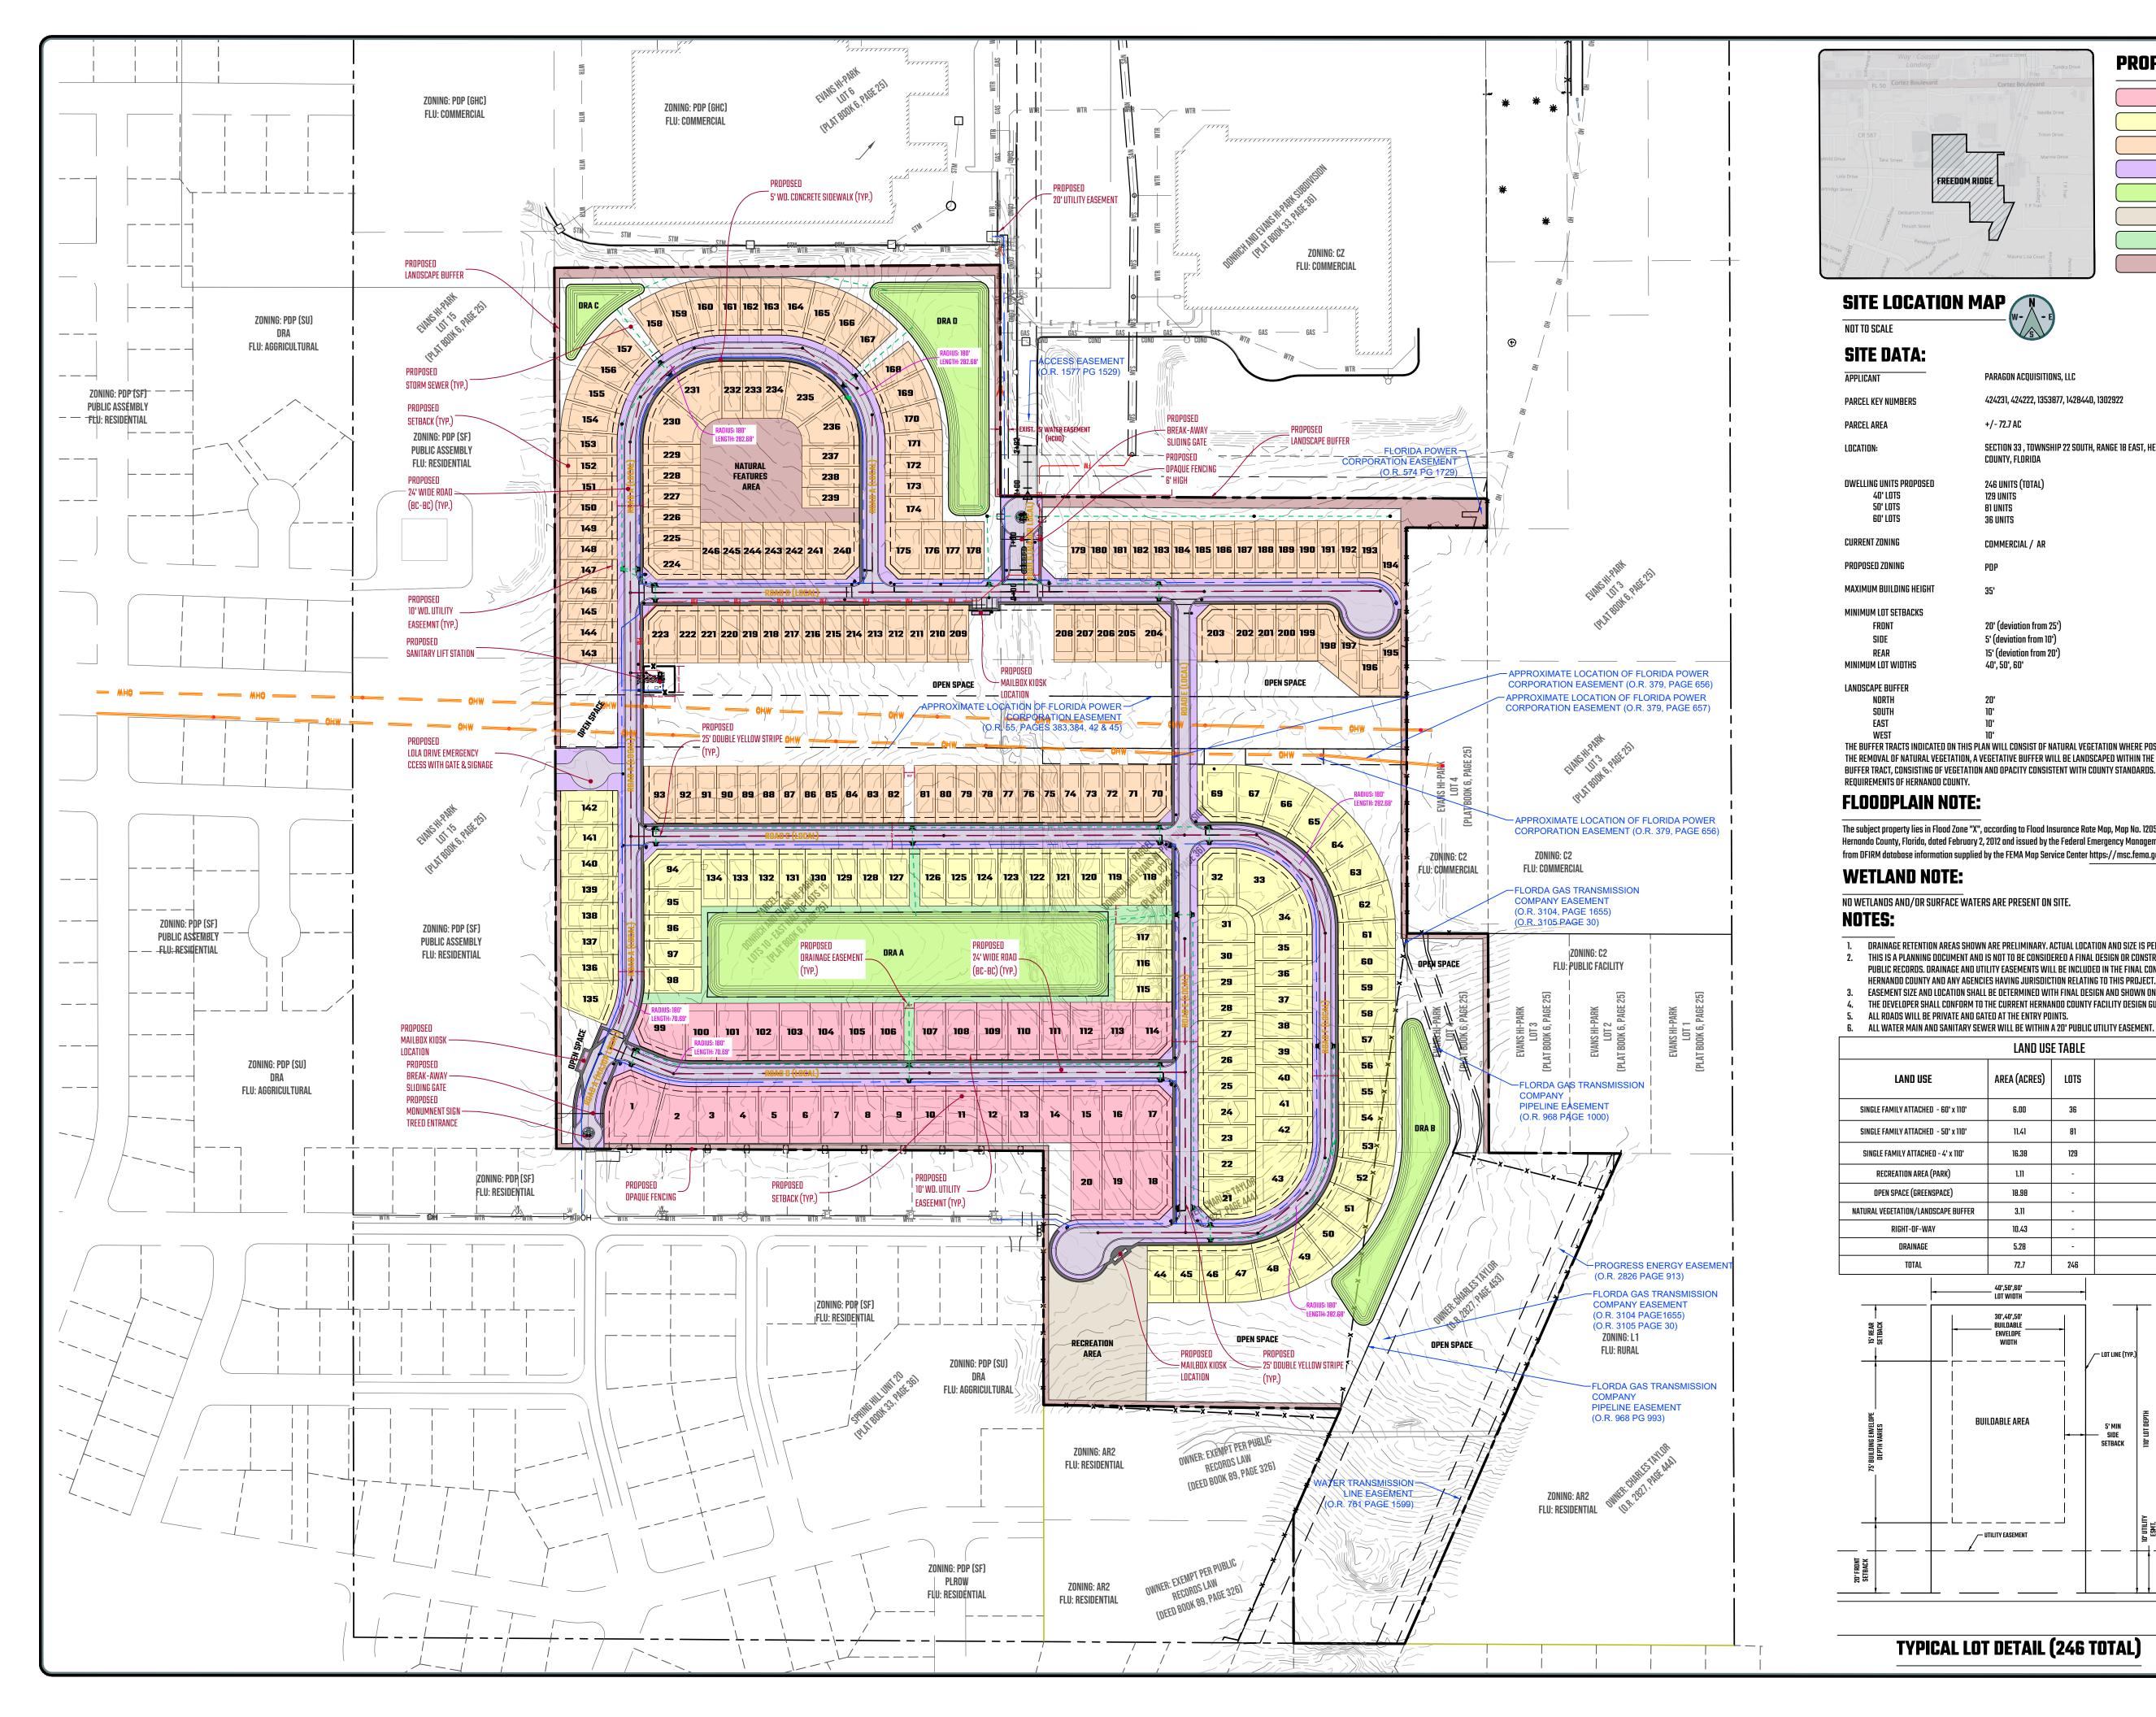



PROPOSED LEGEND

PROPOSED 60' X 110' LOT PROPOSED 50' X 110' LOT PROPOSED 40' X 110' LOT PROPOSED 50' WIDE RIGHT-OF-WAY RETENTION BASIN

RECREATION/PARK AREA OPEN SPACE/GREENSPACE

NATURAL VEGETATION & LANDSCAPE BUFFER

PARAGON ACQUISITIONS, LLC

424231, 424222, 1353877, 1428440, 1302922

+/- 72.7 AC

SECTION 33 , TOWNSHIP 22 SOUTH, RANGE 18 EAST, HERNANDO COUNTY, FLORIDA

246 UNITS (TOTAL) 129 UNITS 81 UNITS 36 UNITS

COMMERCIAL / AR PDP

35'

20' (deviation from 25') 5' (deviation from 10') 15' (deviation from 20') 40', 50', 60'

THE BUFFER TRACTS INDICATED ON THIS PLAN WILL CONSIST OF NATURAL VEGETATION WHERE POSSIBLE, ENHANCED WHERE WHERE SITE GRADING REQUIRES THE REMOVAL OF NATURAL VEGETATION, A VEGETATIVE BUFFER WILL BE LANDSCAPED WITHIN THE BUFFER TRACT, CONSISTING OF VEGETATION AND OPACITY CONSISTENT WITH COUNTY STANDARDS. A VINYL FENCE SHALL BE USED TO MEET OPACITY

The subject property lies in Flood Zone "X", according to Flood Insurance Rate Map, Map No. 12053C0169D for Hernando County, Community No. 120110, Hernando County, Florida, dated February 2, 2012 and issued by the Federal Emergency Management Agency. Lines shown have been digitally translated from DFIRM database information supplied by the FEMA Map Service Center https://msc.fema.gov).


NO WETLANDS AND/OR SURFACE WATERS ARE PRESENT ON SITE.

1. DRAINAGE RETENTION AREAS SHOWN ARE PRELIMINARY. ACTUAL LOCATION AND SIZE IS PENDING FINAL ENGINEERING DESIGN. 2. THIS IS A PLANNING DOCUMENT AND IS NOT TO BE CONSIDERED A FINAL DESIGN OR CONSTRUCTION PLAN AND IS NOT INTENDED FOR RECORDATION IN THE PUBLIC RECORDS. DRAINAGE AND UTILITY EASEMENTS WILL BE INCLUDED IN THE FINAL CONSTRUCTION PLAN AND SHALL MEET THE REQUIREMENTS OF HERNANDO COUNTY AND ANY AGENCIES HAVING JURISDICTION RELATING TO THIS PROJECT.

3. EASEMENT SIZE AND LOCATION SHALL BE DETERMINED WITH FINAL DESIGN AND SHOWN ON FINAL PLAT. THE DEVELOPER SHALL CONFORM TO THE CURRENT HERNANDO COUNTY FACILITY DESIGN GUIDELINES.

ALL ROADS WILL BE PRIVATE AND GATED AT THE ENTRY POINTS.


	LAND US	E TABLE	
	AREA (ACRES)	LOTS	DENSITY
)' x 110'	6.00	36	-
1' x 110'	11.41	81	-
x 110'	16.38	129	-
)	1.11	-	-
E)	18.98	-	-
E BUFFER	3.11	-	
	10.43	-	
	5.28	-	
	72.7	246	APPROX. 3.43

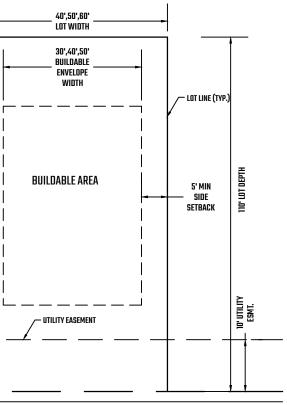


TYPICAL LOT DETAIL (246 TOTAL)


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North	SCALE O' 150' GRAPHIC SCALE: 1" = 15	300'
COUNTY	HILL, HERNAND /, FLORIDA 3461	
Sheet Name CONDIT	IONAL PLAT	
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Checked By:		
PE Project N	o. 22-0008	
Sheet No.	C-200	

AWING NOTE: SCALE SHOWN IS MEANT FOR 22" X 34" AND WILL SCALE INCORRECTLY ON ANY OTHER SIZE MEDIA BESIDES 11" X 17 NO REPRODUCTION SHALL BE MADE WITHOUT PRIOR CONSENT © 2022

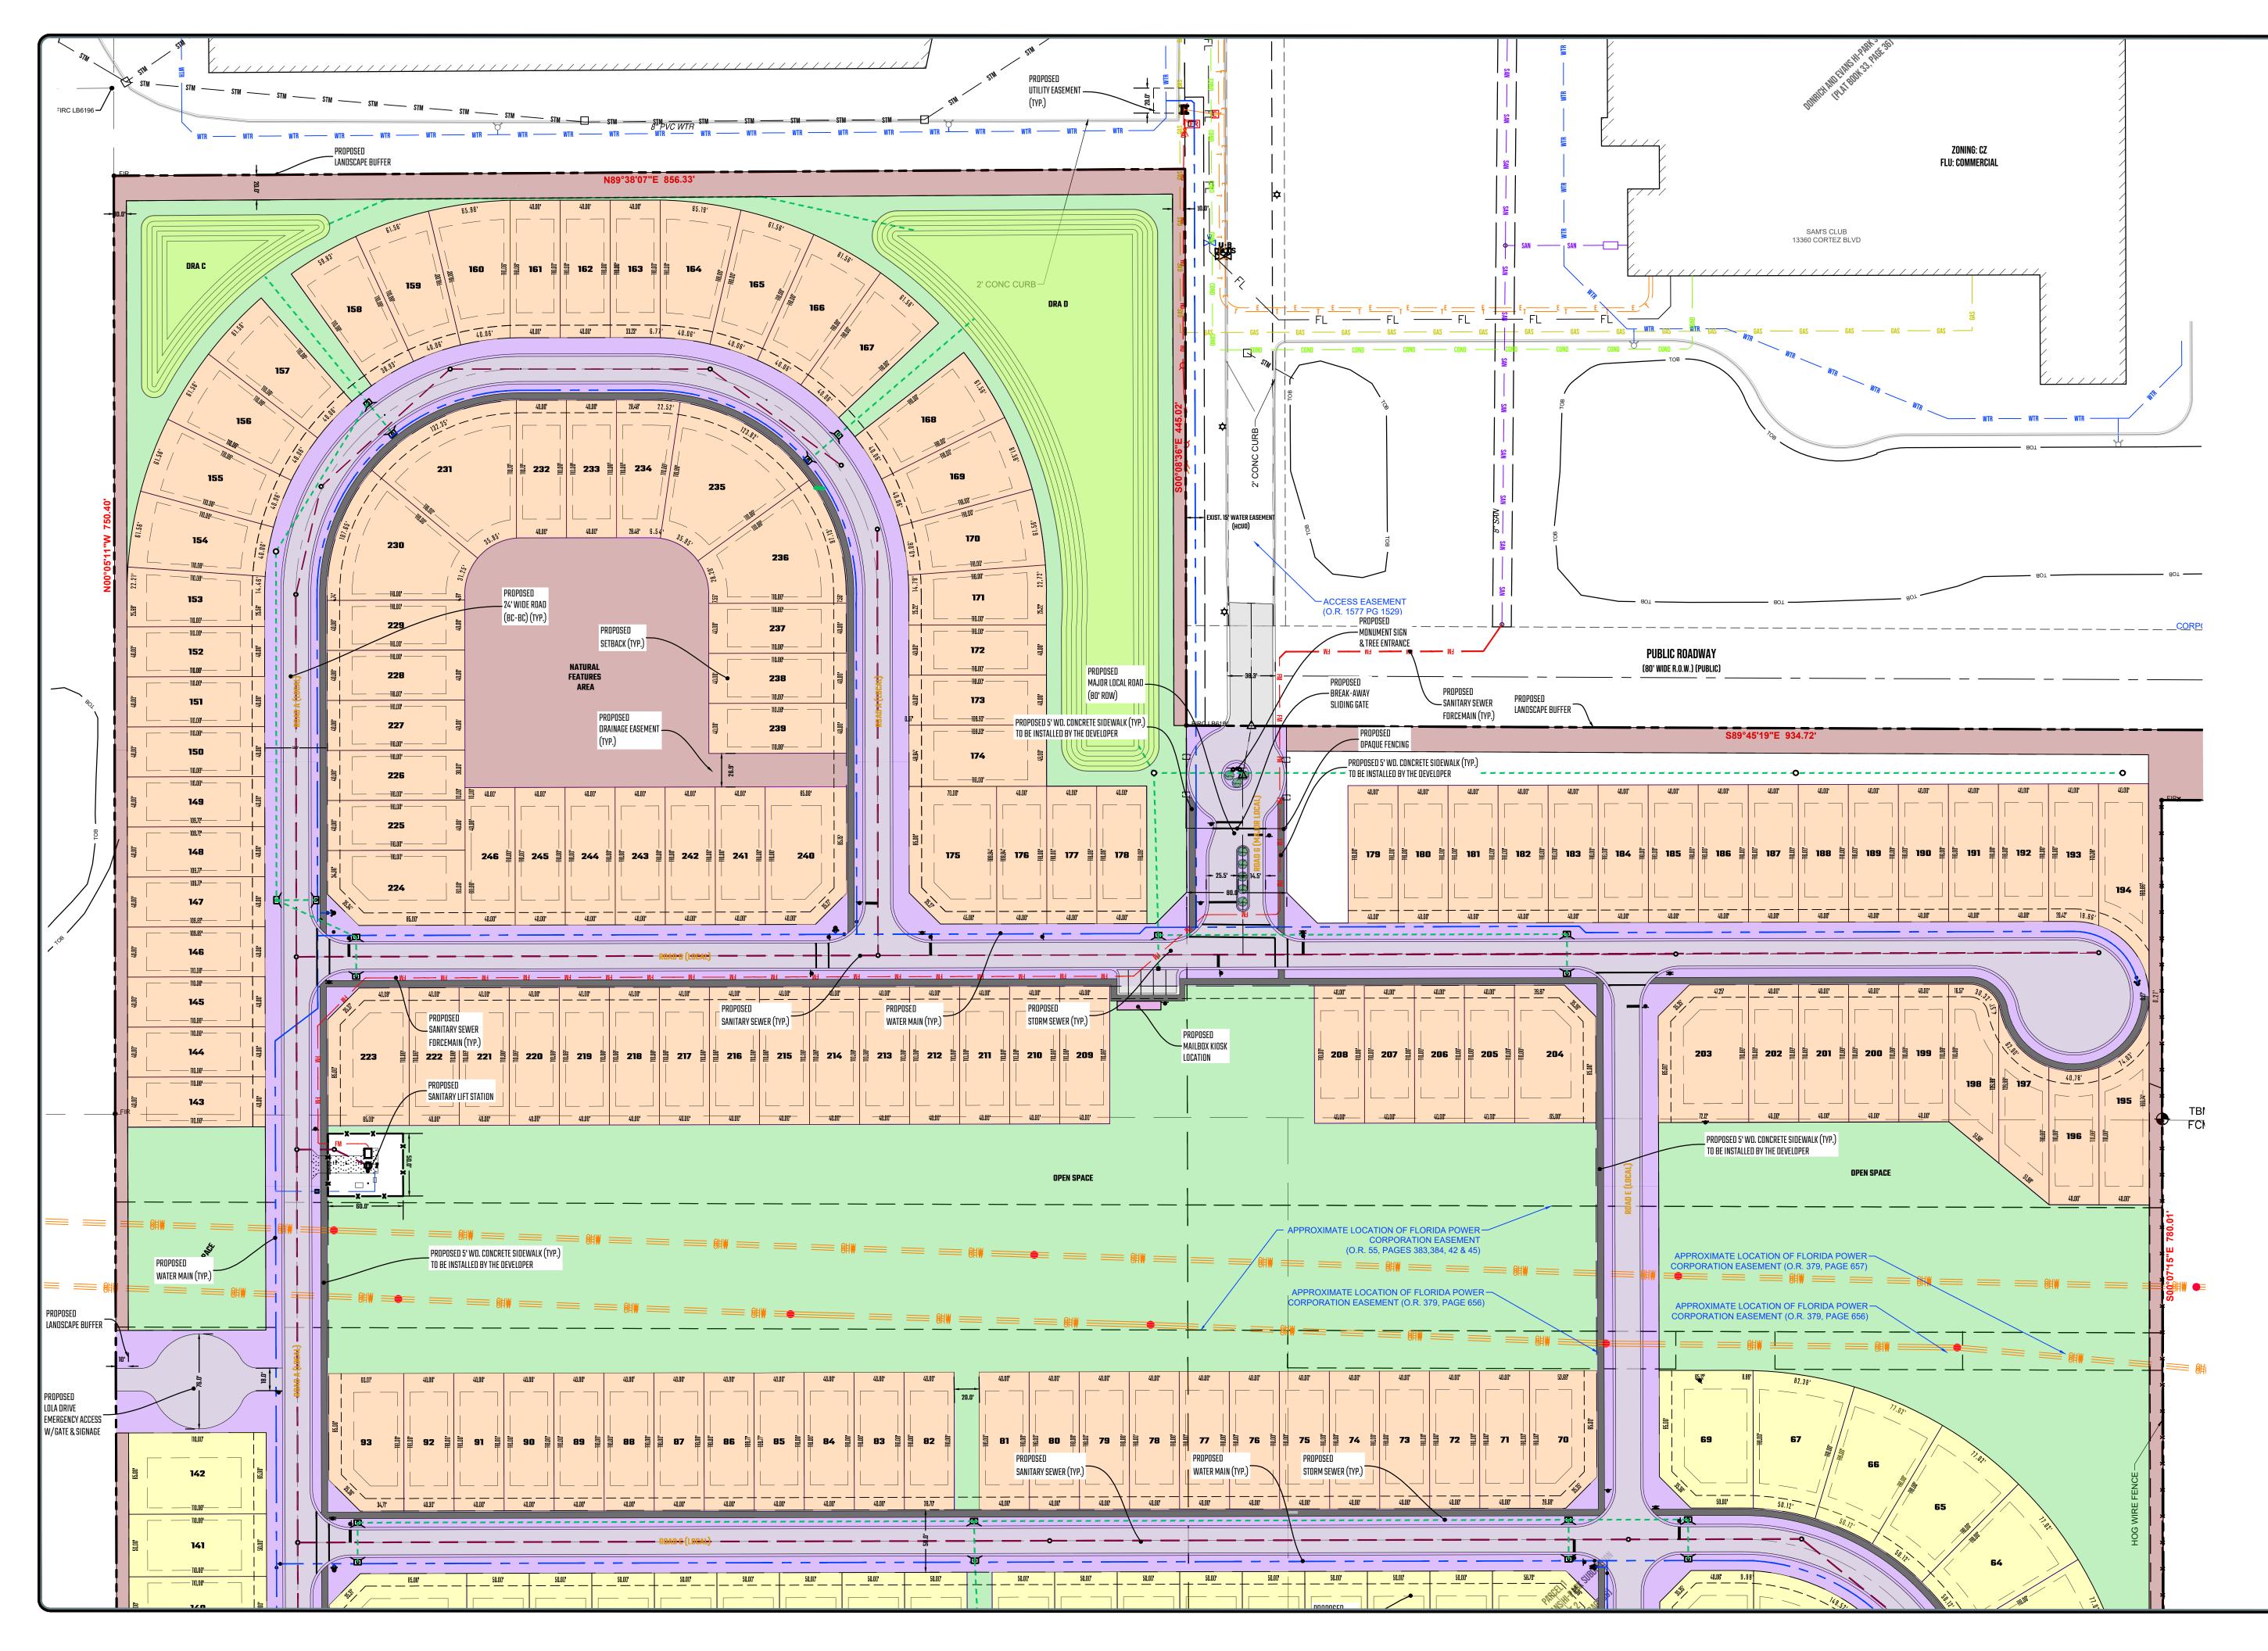


PRIORITY ENGINEERING, LLC	
Engineer's Seal	
No. 80097 STATE OF COR IDA STATE OF COR IDA STATE OF COR IDA STATE OF	
Certification (1) This item has been electronically signed and sealed by Kirt M. Andersen, PE, using a Digital Signature. (2) Printed capies of this document are not considered signed and sealed and the signature must verified on any electronic capies. Kirt M. Andersen, State of Florida, Professional Engineer, License Na. 80097. This item has been electronically signed and sealed by Kirt M. Andersen, PE, as dated on a Digital Signature. Printed capies of this document are not considered signed and sealed and signature must be verified on any electronic capies.	
North SCALE	
	1
GRAPHIC SCALE: 1" = 60' Project	_
Project Location SPRING HILL, HERNANDO COUNTY, FLORIDA 34613	
Sheet Name CONDITIONAL PLAT - NORTH ISSUED FOR CONDITIONAL PLAT APPROVAL	
Revisions	
REV ISSUED FOR ISSUE DATE BY 1 COND PLAT COMMENTS HERNANDO COUNTY 3/11/2024 KMA	
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Date: 06/24/2022	
Date: 06/24/2022 Reviewed By: BF	
Reviewed By: BF ENG/CADD: BH	
Reviewed By: BF	
Reviewed By: BF ENG/CADD: BH	

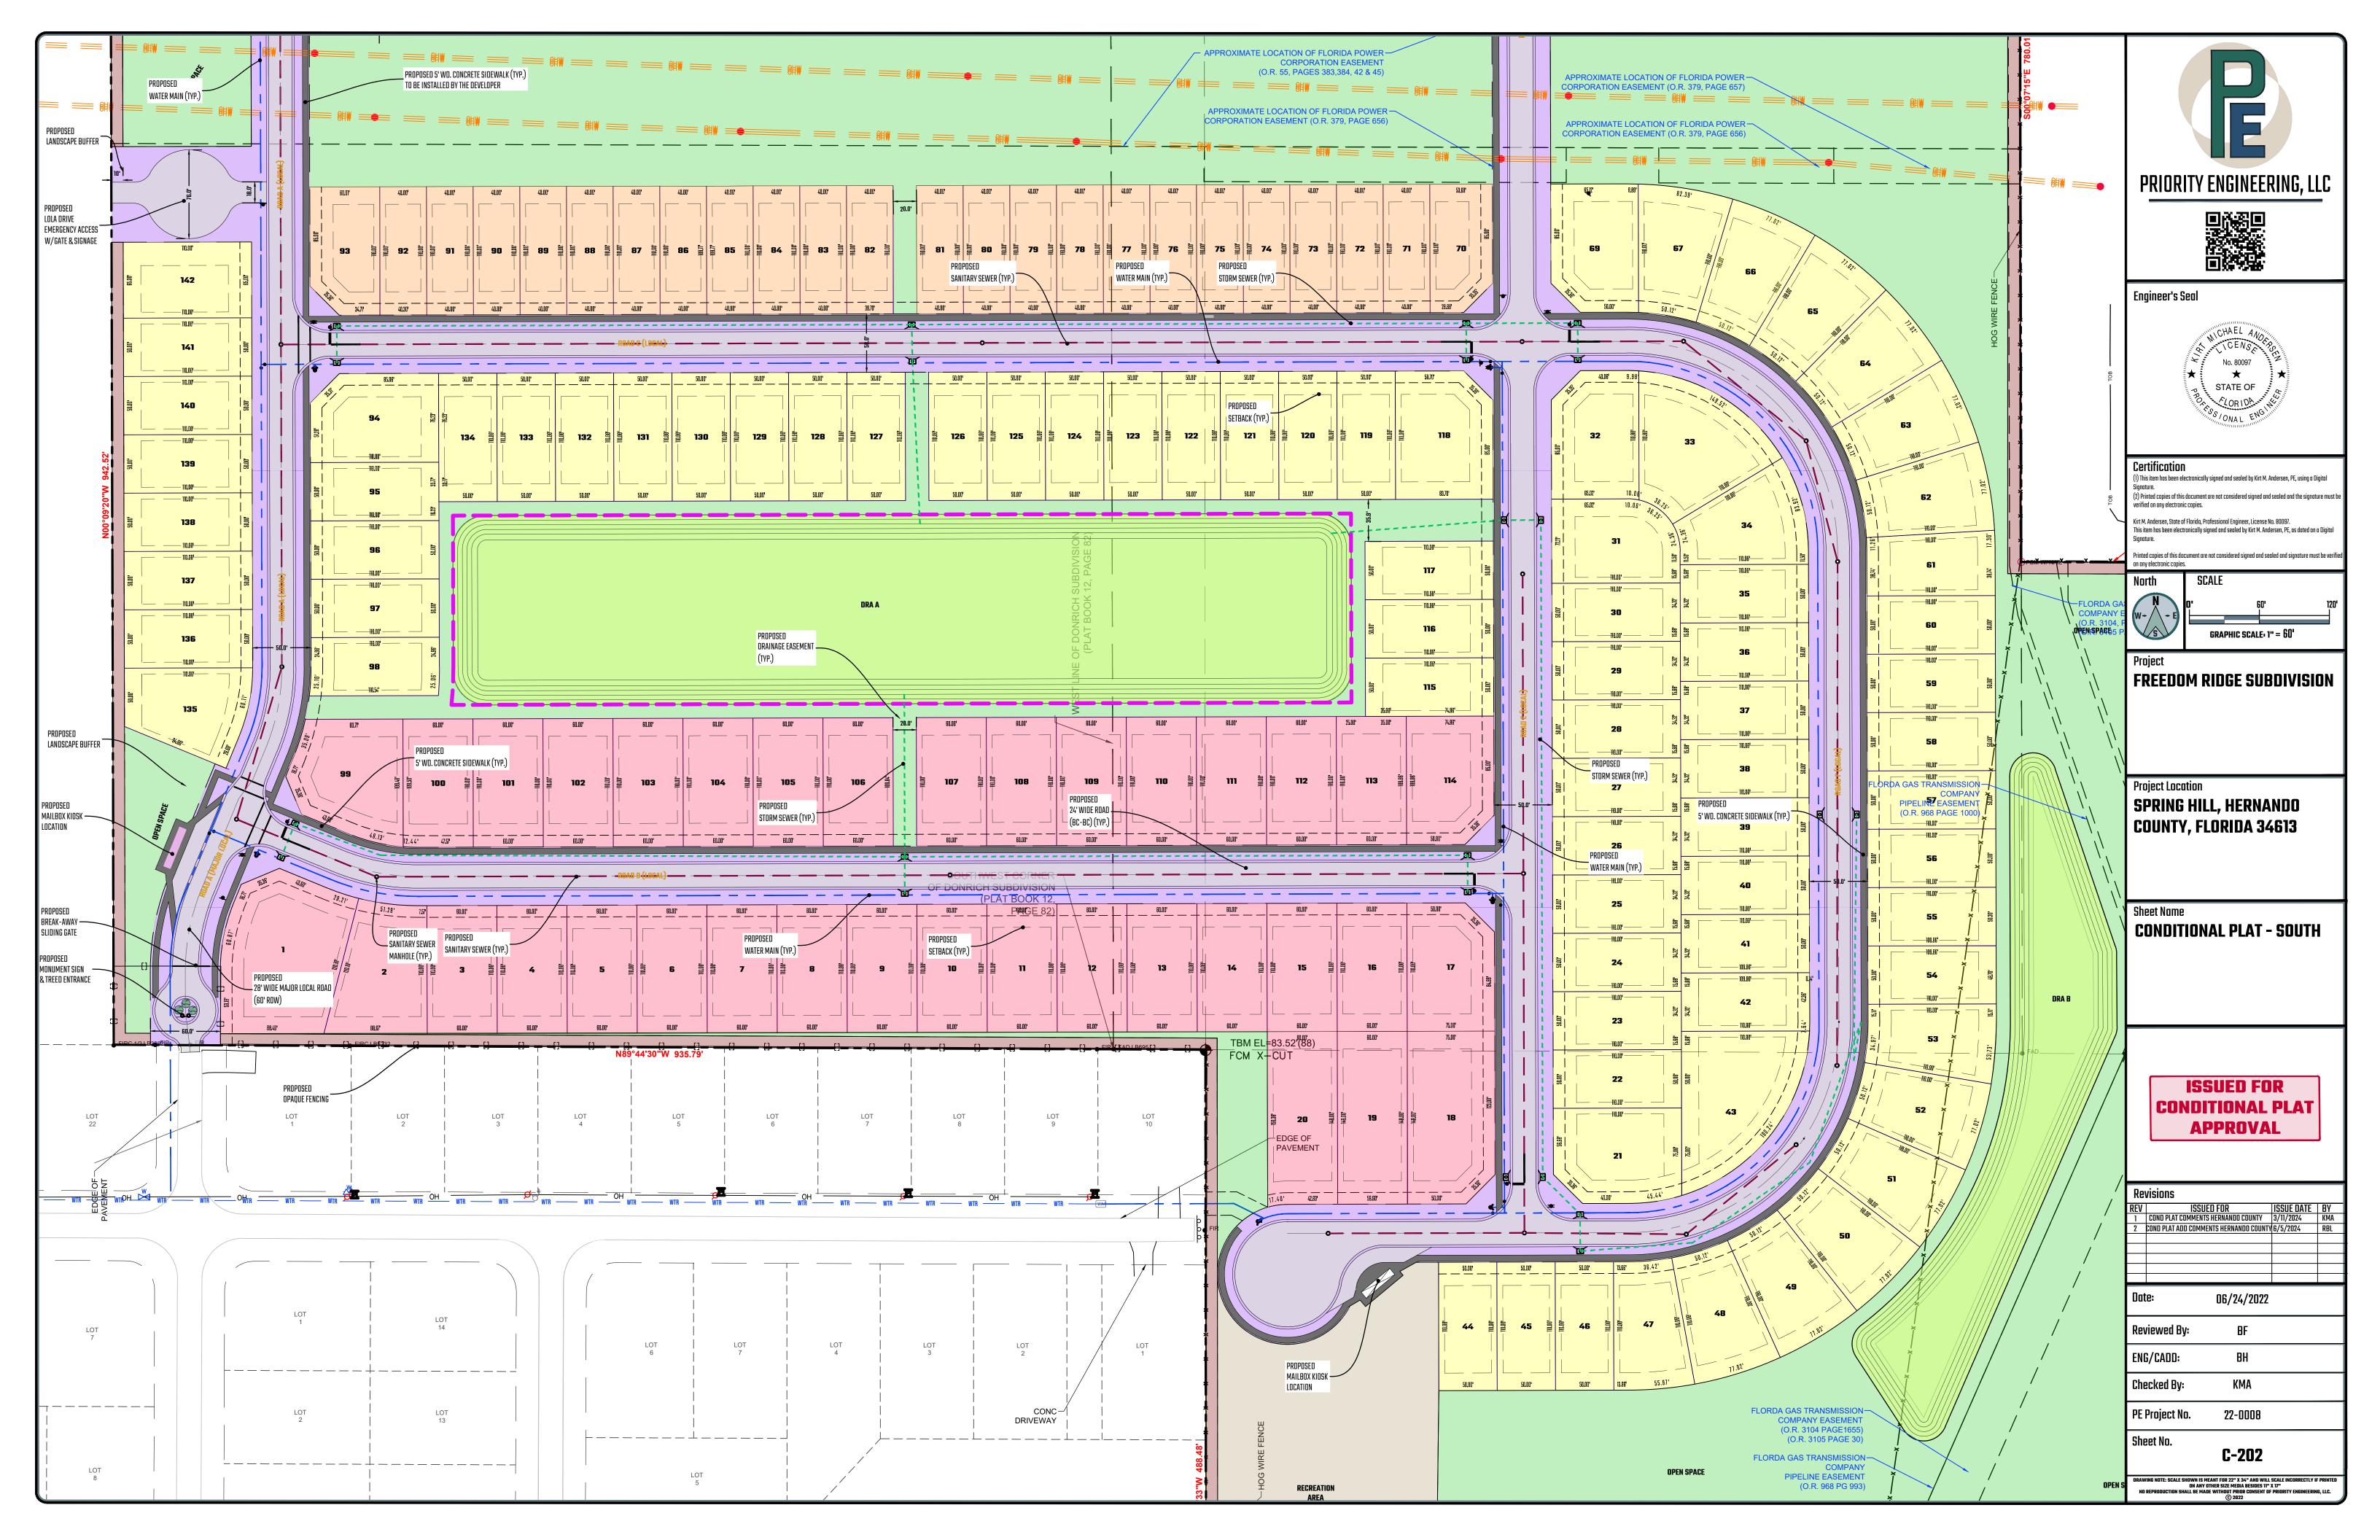

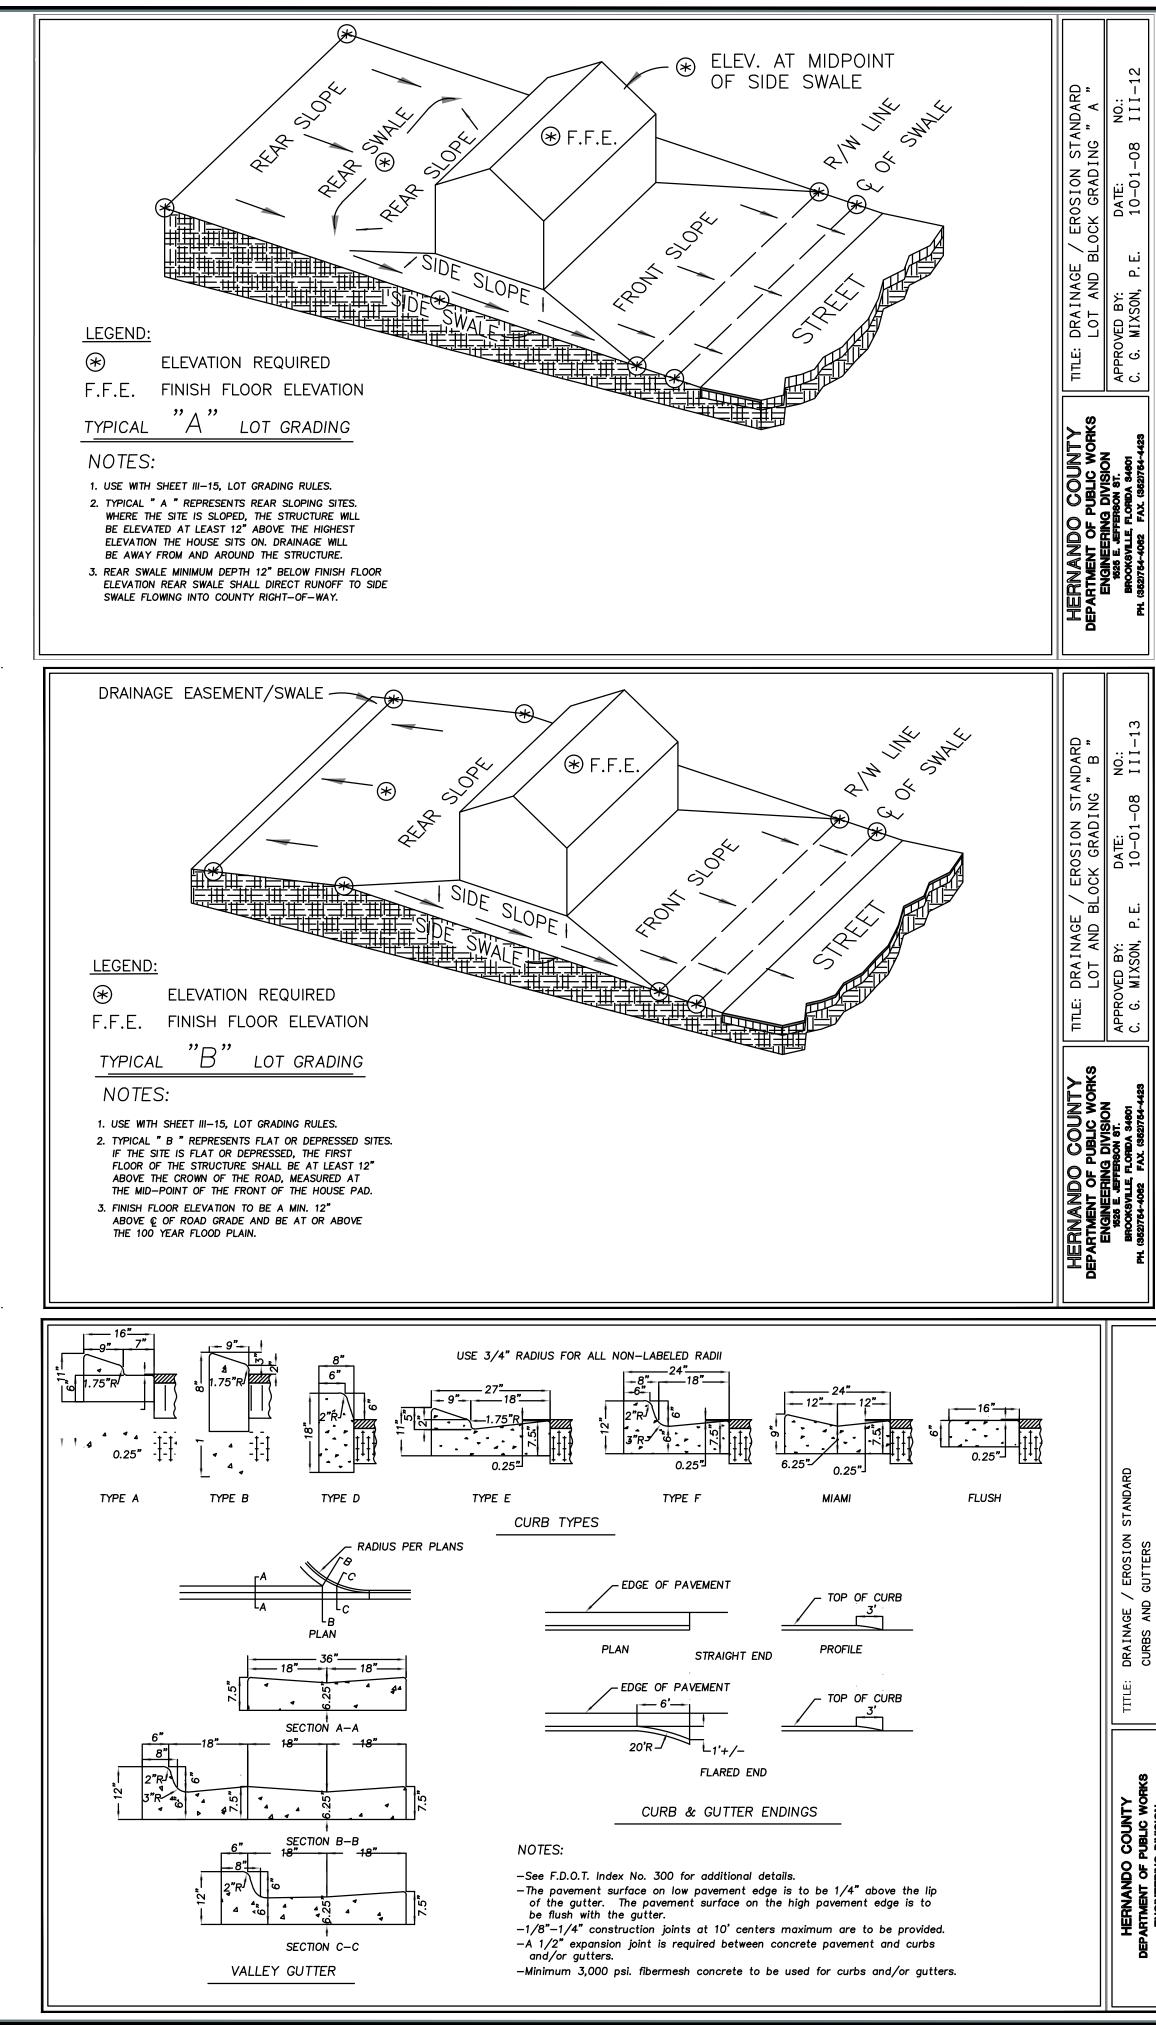



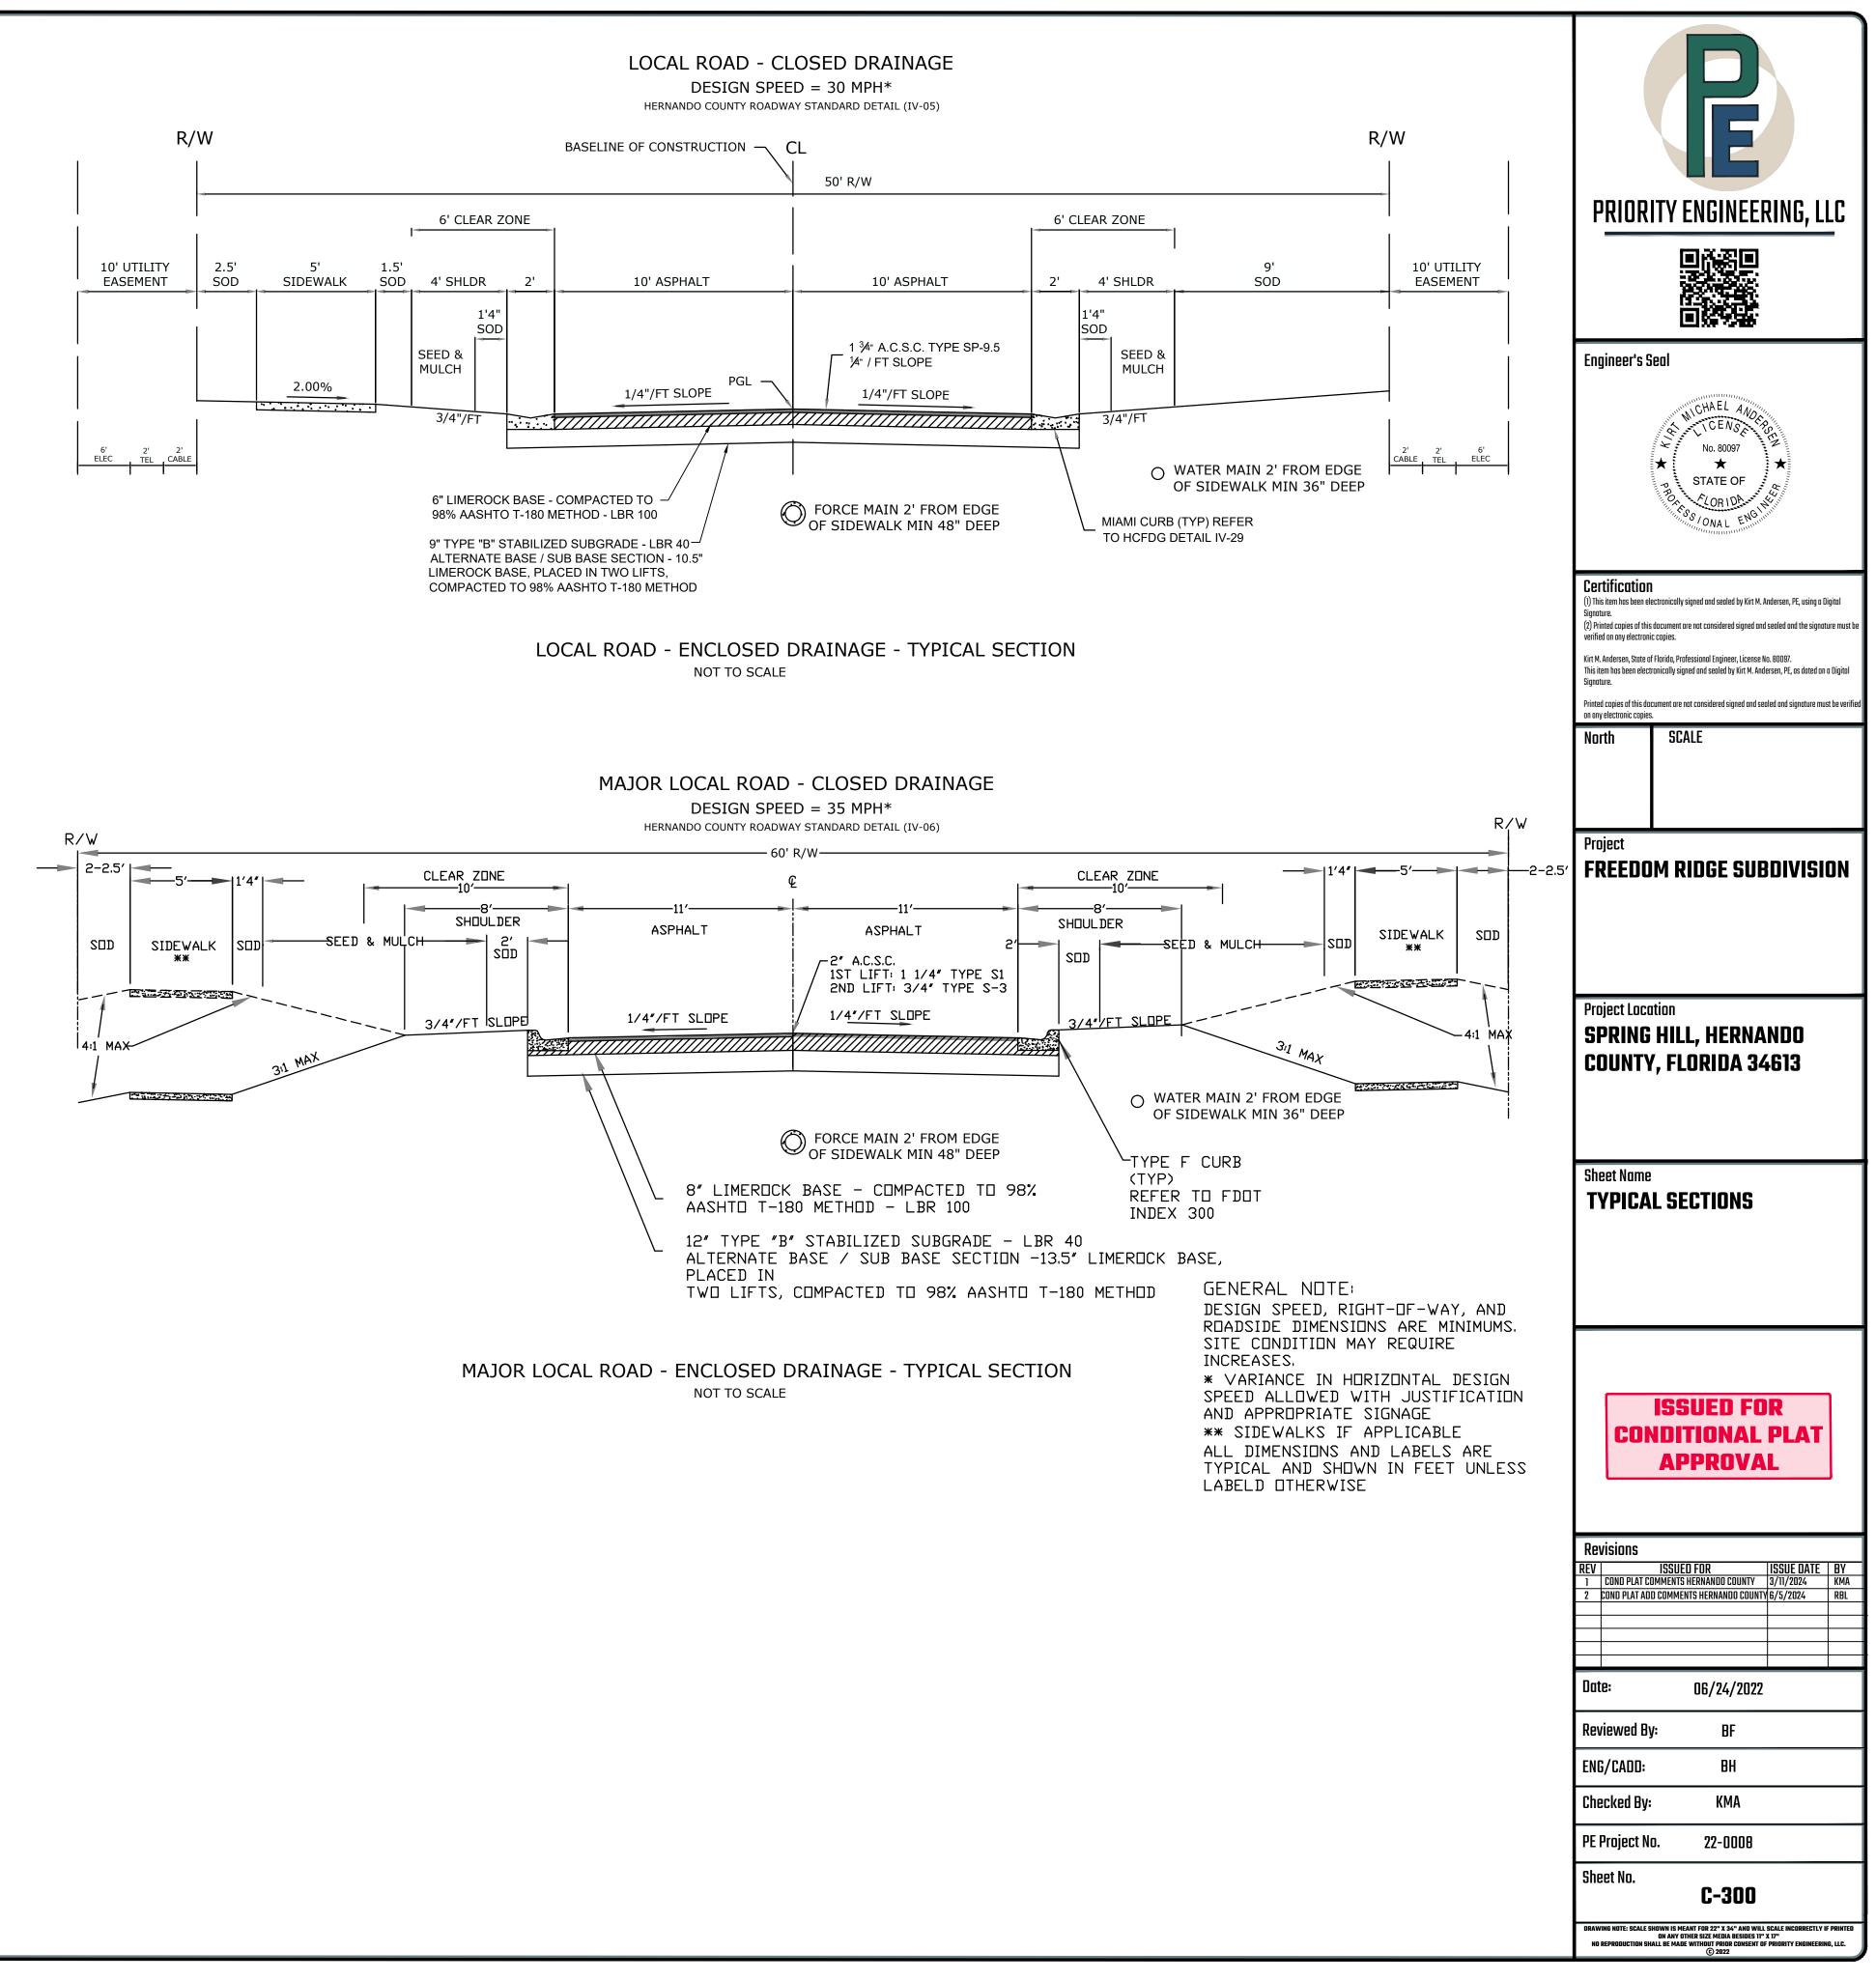

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	RESOLUTION NO. 2021 - <u>207</u>
Chapter 163, Florid	ndo County has adopted zoning regulations pursuant to Section 125.01(1) and <i>da Statutes</i> , which authorize the County to regulate the use of land in the s of Hernando County, Florida, and take action on the request herein; and,
advertised public he	lernando County Board of County Commissioners (BOCC) conducted a duly aring on November 16, 2021, to consider the requested changes in zoning on the Hernando County, Florida, as more fully described below.
NOW, THEREFOI OF HERNANDO C	RE, BE IT RESOLVED BY THE BOARD OF COUNTY COMMISSIONERS COUNTY, FLORIDA, AS FOLLOWS:
APPLICANT:	Theodoros N. Zorbas; Charles S. Taylor Living Trust
FILE NUMBER:	H-21-34
REQUEST:	Rezoning from A/R(Agricultural/Residential), A/R-2(Agricultural/Residential-2) and C-2/(Highway Commercial) to PDP(SF)/Planned Development Project (Single-Family), with Deviations
GENERAL LOCATION:	Northern Terminus of Gainsboro Avenue, and Eastern Terminus of Delbarton Street
PARCEL KEY NUMBERS:	1302922, 424231, 424222, 1353877, 1428440
REQUEST:	Rezoning from A/R(Agricultural/Residential), A/R-2(Agricultural/Residential-2) and C-2/(Highway Commercial) to PDP(SF)/Planned Development Project (Single-Family), with Deviations, as enumerated in the BOCC Action, which is incorporated herein by reference and made a part hereof. The representations contained in the rezoning application are incorporated herein by reference and made a part hereof. For purposes herein, it is presumed that all notice and advertising requirements have been satisfied.
FINDINGS OF FACT:	 ALL of the facts and conditions set forth in the County's staff memoranda and presented to the BOCC in connection with the public hearing in this matter are incorporated herein by reference and made a material part of this Resolution as integral to the BOCC's Action. The BOCC finds that the testimony and record supporting <u>APPROVAL</u> of the request to be credible and to constitute competent substantial evidence. In further support thereof, the BOCC makes the following specific findings of fact: 1. The proposed request is consistent with the County's adopted Comprehensive Plan and is compatible with the surrounding land uses.

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Hernando County Planning Department

Staff Report: H-21-34

BOCC ACTION:

On November 16, 2021, the Board of County Commissioners voted 5-0 to adopt Resolution 2021-207 approving the petitioner's request for a rezoning from AR/(Agricultural/Residential), AR-2/(Agricultural/ Residential-2) and C-2/(Highway Commercial) to PDP(SF)/Planned Development Project (Single Family) with deviations and with the following modified performance conditions:

- 1. The petitioner must obtain all permits from Hernando County and other applicable agencies and meet all applicable land development regulations, for either construction or use of the property, and complete all applicable development review processes.
- 2. A comprehensive floral and wildlife (faunal) survey shall be prepared by a qualified professional. The petitioner is required to comply with all applicable FWC regulations and permitting.
- 3. The petitioner must meet the minimum requirements of Florida Friendly Landscaping[™] publications and the Florida Yards and Neighborhoods Program for design techniques, principles, materials and plantings for required landscaping, as applicable.
- 4. The Builder/Developer shall provide new property owners with Florida-Friendly Landscaping[™] (FFL) Program information and include FFL language in the HOAs covenants and restrictions. Information on the County's Fertilizer Ordinance and fertilizer use is to be included. Educational information is available through Hernando County Utilities Department.
- 5. Geotechnical subsurface testing and reporting in accordance with Hernando County's Facility Design Guidelines shall be conducted for all proposed drainage retention or detention areas within the project.
- 6. Any substandard roadways and access will require upgrades and improvements in accordance with the requirements of the County Engineer and the Facility Design Guidelines.
- 7. The petitioner shall design the stub-out to Lola Drive as a turnaround, meeting all Hernando County Facility Design Guidelines and the requirements of the Hernando County Fire and Emergency Services Department. If at any time Lola Drive is extended, allowing an interconnect to the subject property, the turnaround can be removed the property can connect to Lola Drive, providing an emergency access from the development. This emergency access shall be designed in accordance with the requirements of the County Engineer and the Hernando County Fire and Emergency Services Department.

CONCLUSIONS OF LAW:

The BOCC is authorized to act on this matter pursuant to Chapters 125 and 163, Florida Statutes. Accordingly, after public hearing and testimony, being fully advised in the record, and based upon competent substantial evidence, the BOCC makes the following specific conclusions of law:

1. The proposed request is consistent with the County's adopted Comprehensive Plan and is compatible with the surrounding land uses.

ACTION:

After notice and public hearing, based upon the record in this matter and ALL of the findings of fact and conclusions of law above, the BOCC hereby APPROVES the request for a Rezoning from A/R(Agricultural/Residential), A/R-2 (Agricultural/Residential-2) and C-2/(Highway Commercial) to PDP(SF)/ Planned Development Project (Single-Family), with Deviations, as set forth in the BOCC Action, which is incorporated herein by reference and made a part hereof. Any requests, uses, variances or exceptions that were requested in connection with this rezoning application but not specifically approved herein are hereby deemed

DENIED.

Attest: Juscon Burns, Depu Douglas A. Chorvat, Jr. **Clerk of Circuit Court & Comptroller**



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Hernando County Planning Department

- Access Analysis in accordance with the requirem
- existing vegetation): North: 20' (for the entire property line) South: 10' supplemented with a 6' fence East: 10' West: 10'
- 10. Minimum Lot Setbacks, widths and sizes: Front: 20' (Deviation from 25') Side: 5' (Deviation from 10') 15' (Deviation from 20') Rear:
- the County's Land Development Regulations.
- part of the required open space.
- County.
- utilities with the conditional plat.

ADOPTED IN REGULAR SESSION THE 16th DAY OF NOVEMBER 2021.

BOARD OF COUNTY COMMISSIONERS HERNANDO COUNTY, FLORIDA



-	a Sufficiency	
By:	ShannonEller	

Staff Report: H-21-34

8. In conjunction with the conditional plat phase, the petitioner shall perform a Traffic its of the County Engineer. Any identified improvements shall be the responsibility of the developer.

9. Minimum Landscape Buffer (minimum 80% opacity with retention/enhancement of

Minimum lot widths: 40', 50' and 60' (40' and 50' Deviation from 60')


11. The developer shall conduct a water and sewer capacity analysis during the conditional plat phase and connect to the central water and sewer systems at time of vertical construction. Any offsite improvements to ensure capacity is available to serve the development shall be the responsibility of the developer.

12. The petitioner shall provide the minimum neighborhood park acreage as required by

13. The petitioner shall preserve the minimum seven percent (7%) natural vegetation as required by the County's LDRs. The required natural vegetation may be included as

14. The petitioner must apply for and receive a Finding of School Capacity from the School District prior to the approval of the conditional plat or the functional equivalent. The County will only issue a certificate of concurrency for schools upon the School District's written determination that adequate school capacity will be in place or under actual construction within three (3) years after the issuance of subdivision approval or site plan approval (or functional equivalent) for each level of school without mitigation, or with the execution of a legally binding proportionate share mitigation agreement between the applicant, the School District, and the

15. The developer shall provide utility placement details showing the locations of all

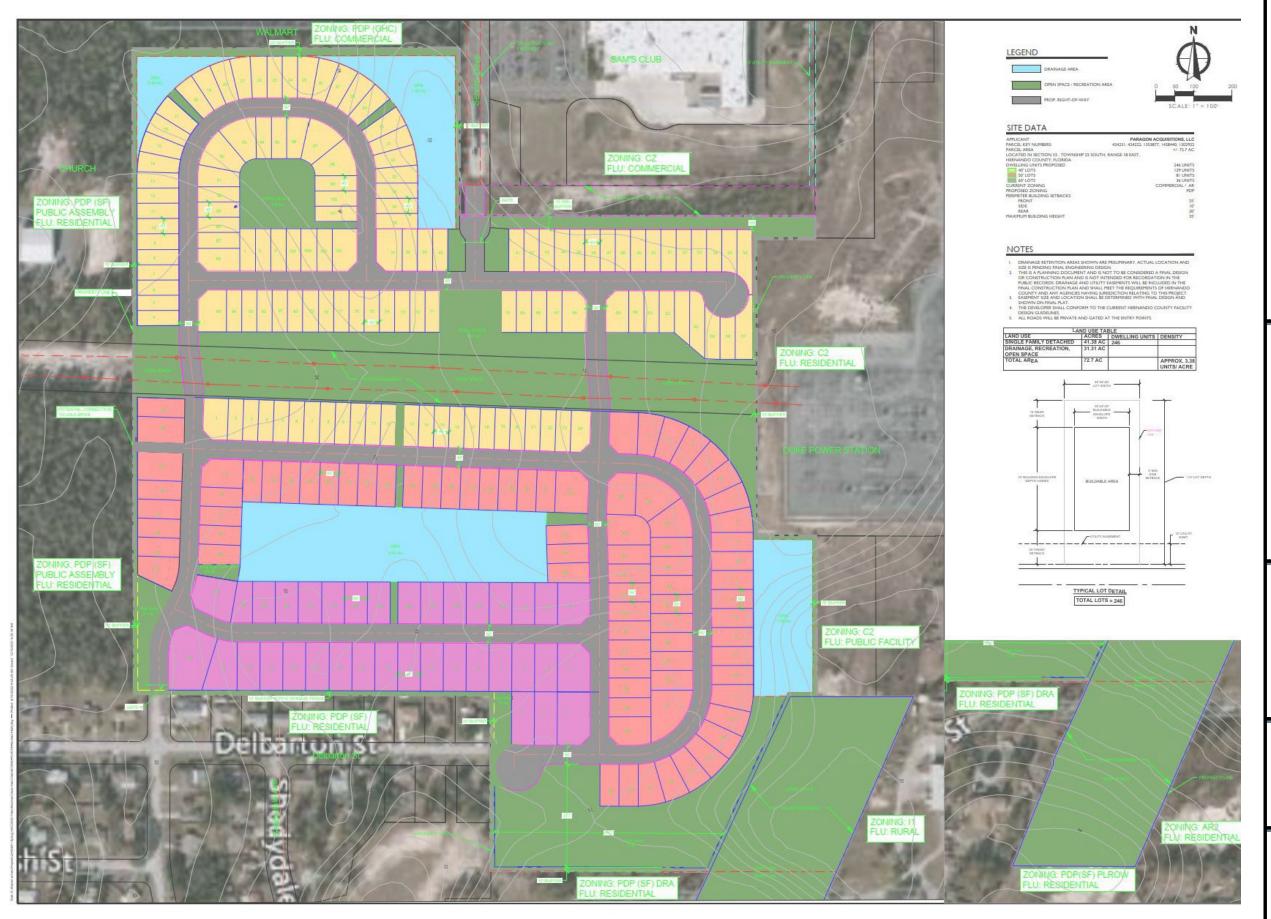

Hernando County Planning Department

Staff Report: H-21-34

- 16. The petitioner shall submit a fire protection plan with the Conditional Plat in accordance with Hernando County LDRs.
- 17. At the time of construction plan approval, the petitioner shall apply for and receive a right-of-way use permit for access to the County right-of-way between the subject site and the Sam's Club easement to allow connectivity for the subject development to the easement.
- 18. The subdivision shall be gated with resident-only access, designed in accordance with the requirements of the County Engineer and the Hernando County Fire and Emergency services.
- 19. The internal roadway network shall be privately maintained. A Homeowners' Association will be established in accordance with the subdivision regulations to maintain the roadways, associated privately maintained infrastructure and drainage associated with the project.
- 20. The petitioner shall provide a treed boulevard entrance into the development from the Sam's Club easement to the north, and a secondary access from Gainsboro Avenue. Delbarton Street. No access shall be granted from Delbarton Street. Gainsboro Avenue.
- 21. The petitioner shall provide a revised plan in compliance with all the performance conditions within 30 calendar days of BCC approval. Failure to submit the revised plan will result in no further development permits being issued.

PRIORITY ENGINEERING, LLC PRIORITY ENGINEERING, LLC Engineer's Seal
No. 80097
No. 80097
STATE OF
Certification (1) This item has been electronically signed and sealed by Kirt M. Andersen, PE, using a Digital Signature. (2) Printed copies of this document are not considered signed and sealed and the signature must be verified on any electronic copies.
Kirt M. Andersen, State of Florida, Professional Engineer, License No. 80097. This item has been electronically signed and sealed by Kirt M. Andersen, PE, as dated on a Digital Signature.
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North SCALE
Project Location
SPRING HILL, HERNANDO
SPRING HILL, HERNANDO COUNTY, FLORIDA 34613 Sheet Name CONDITIONS OF APPROVAL
COUNTY, FLORIDA 34613 Sheet Name
COUNTY, FLORIDA 34613 Sheet Name
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